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DEVELOPMENT **APPLICATION**

REVISION DATE DESCRIPTION

01/12/2017 DEVELOPMENT APPLICATION PM 09/07/2018 S34 UPDATE

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DEVELOPMENTS 2 DELMAR PARADE,

DEE WHY, NSW

DRAWING TITLE VIEWS - SHEET 2

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ЈОВ 17079	DRAWING DA7-02		REVISION 2





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DEVELOPMENT **APPLICATION**

REVISION DATE DESCRIPTION 01/12/2017 DEVELOPMENT APPLICATION PM

VIEW 1





VIEW 3

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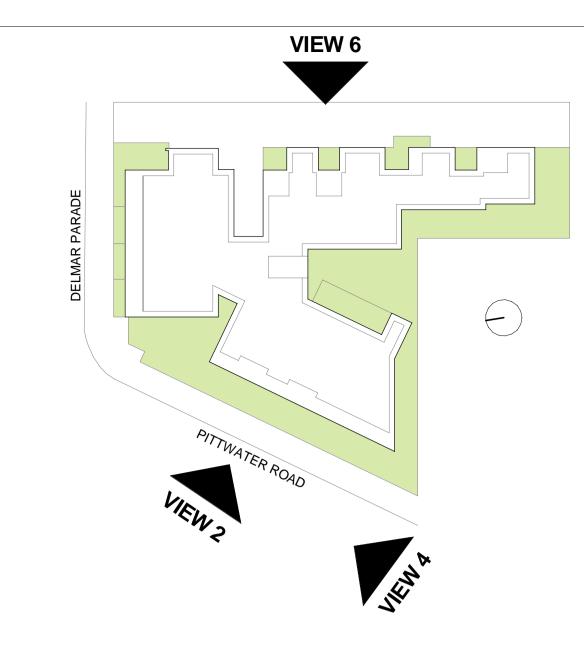
2 DELMAR PARADE, DEE WHY, NSW

DRAWING TITLE

PHOTOMONTAGES -SHEET 1

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VIEW 4

VIEW 5





VIEW 6

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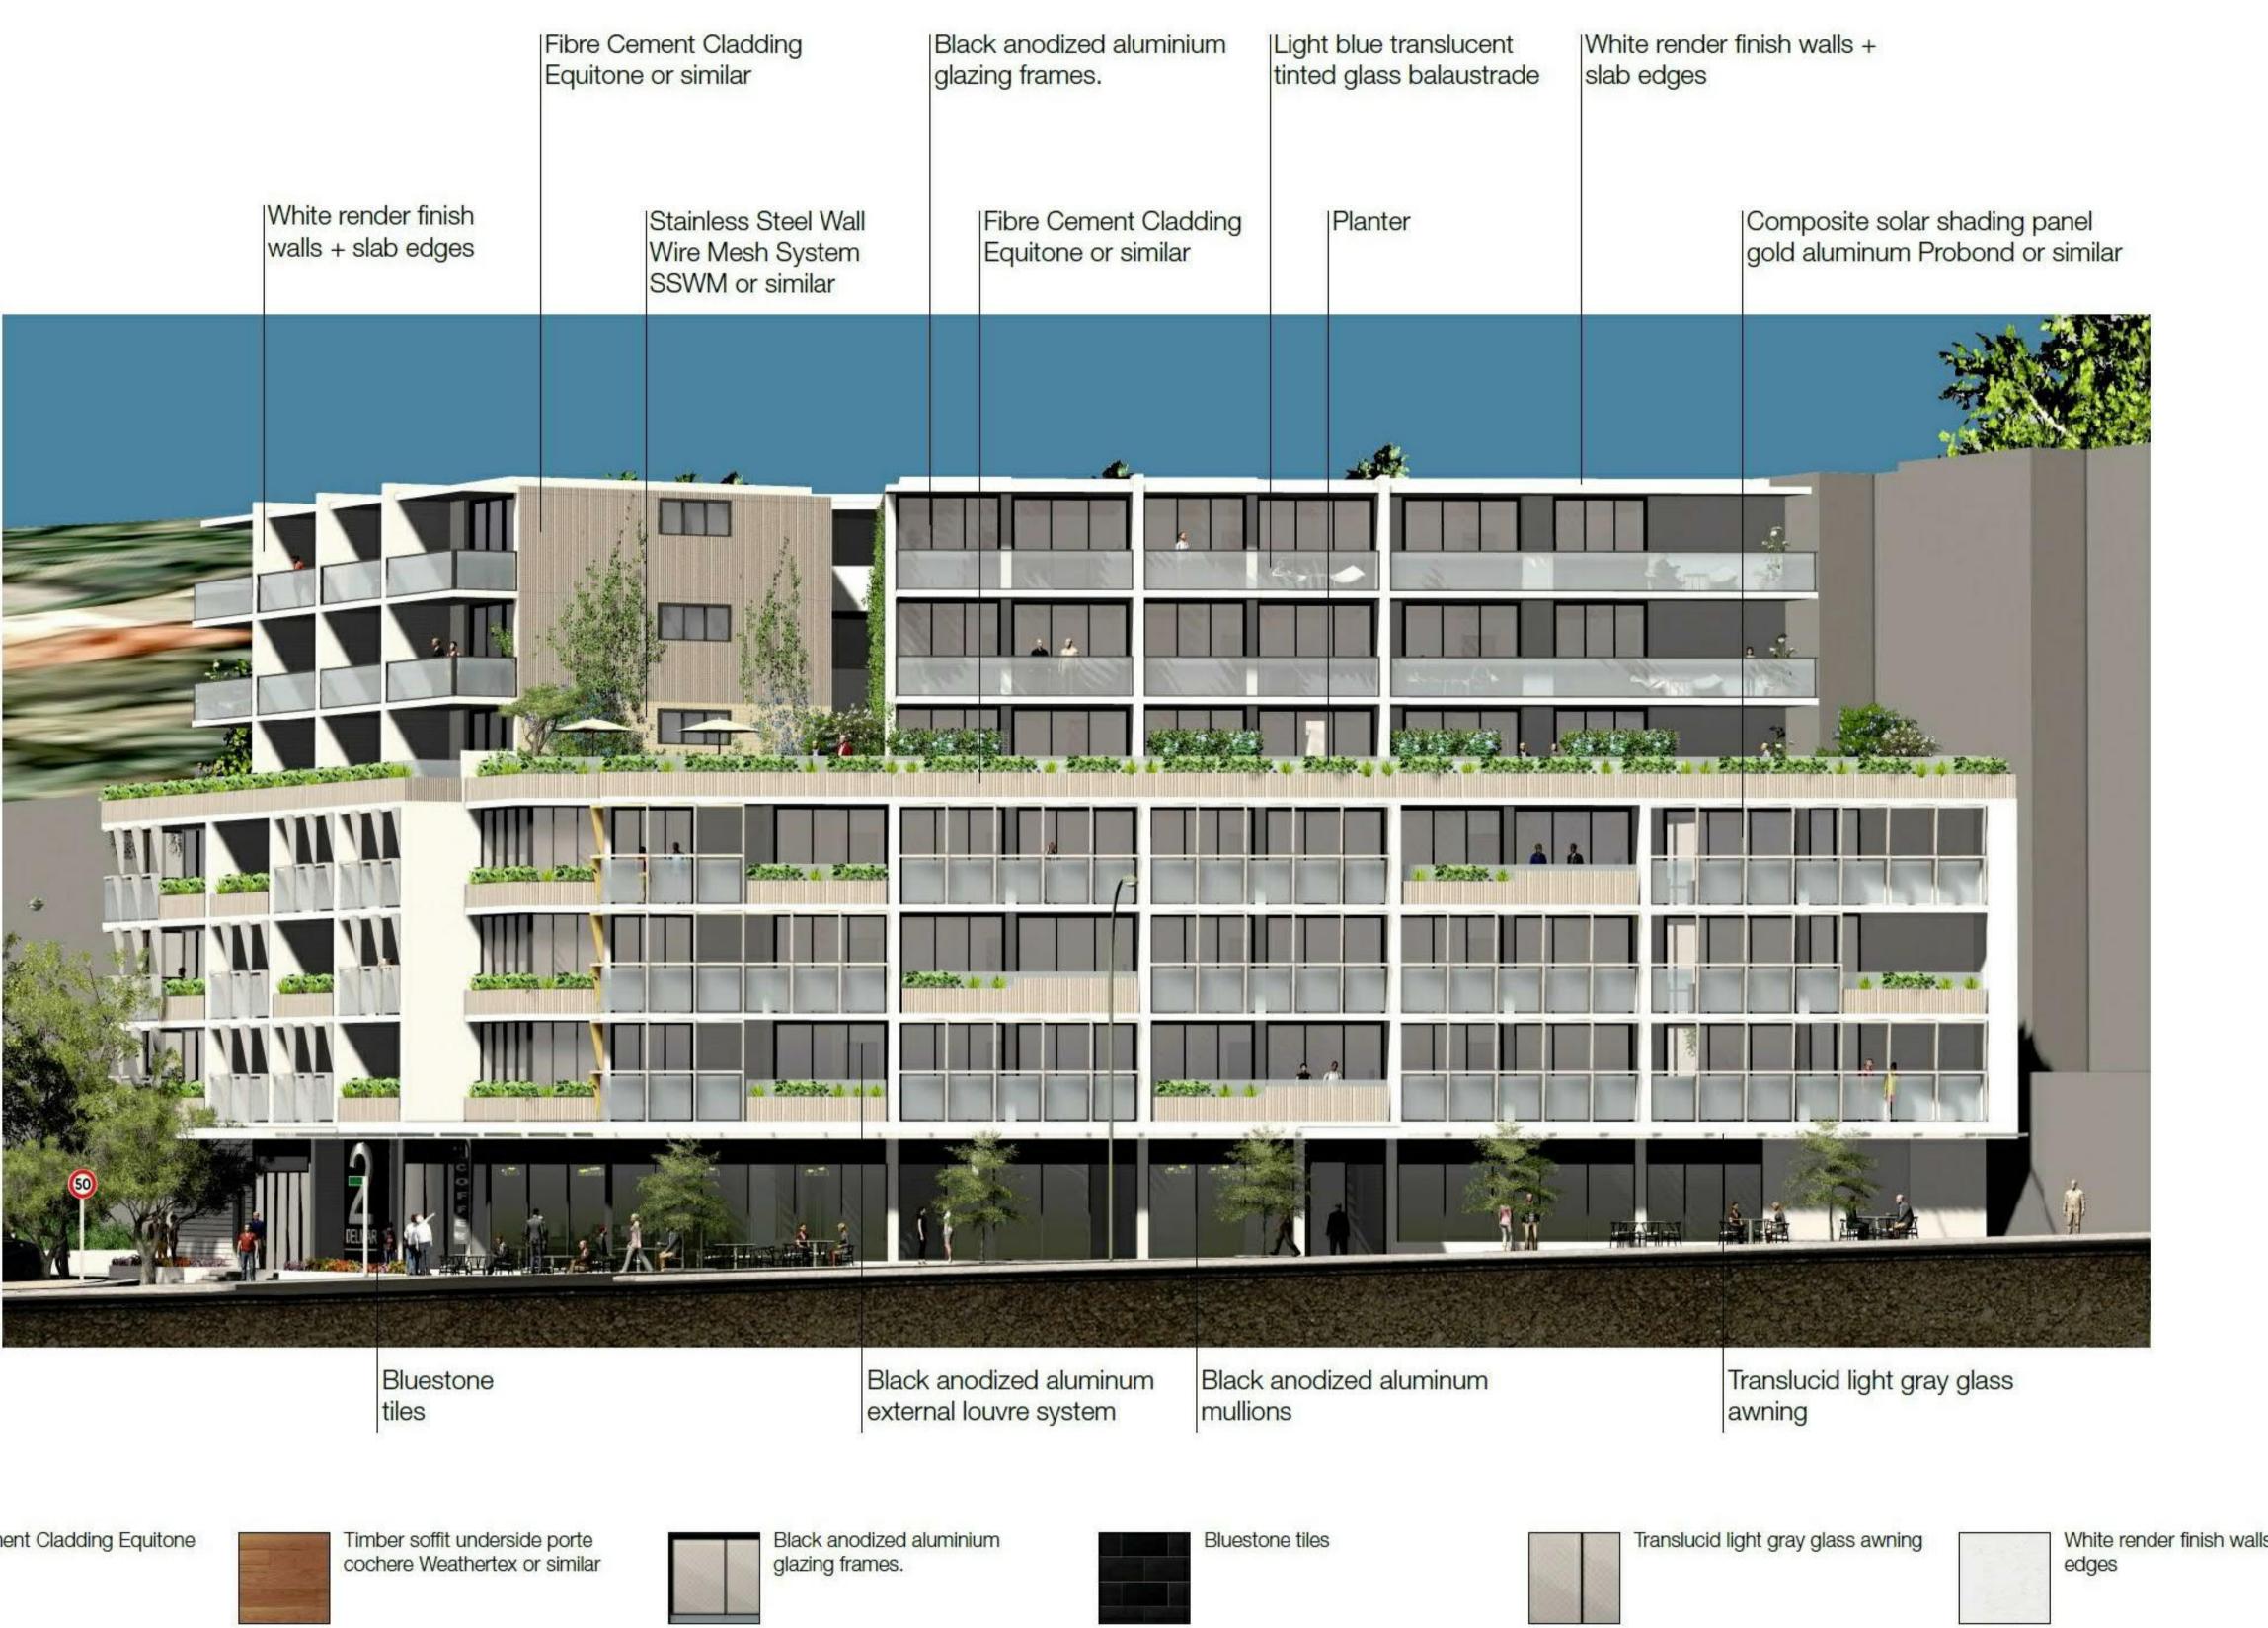
DRAWING TITLE PHOTOMONTAGE -SHEET 2

DEE WHY, NSW

2 DELMAR PARADE,

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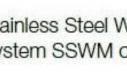
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Fibre Cement Cladding Equitone or similar

White render finish walls + slab





System SSWM or similar

Lighweight cement type Sycon axxon cladding or similar



Black anodized aluminium mullions



Composite solar shading panel gold aluminum Probond or similar



Light blue translucent tinted glass balaustrade



Black anodized aluminum external louvre system louvreclad or similar



Stainless Steel Wall Wire Mesh

*ALL CLADDING MATERIALS WITH NON-COMBUSTIBLE PROPERTY ONLY AS PER BCA STANDARD.

DRAWING TITLE **EXTERIOR FINISHES**

IMPORTANT NOTES:

REVISION DATE DESCRIPTION

01/12/2017 DEVELOPMENT APPLICATION

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APPLICATION

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NOTE: THESE VIEWS ARE ONLY FOR MATERIAL / FACADE FINISH REFERENCE.



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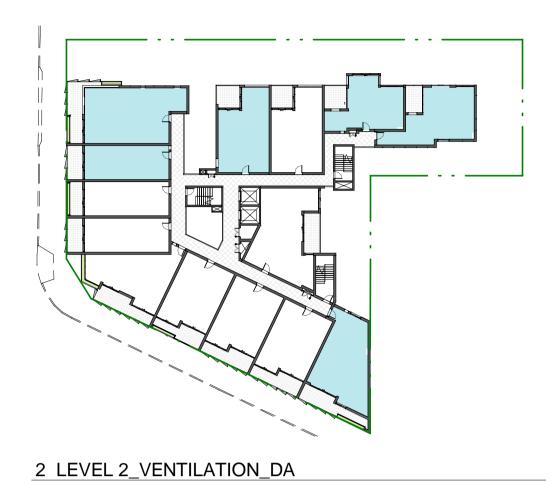
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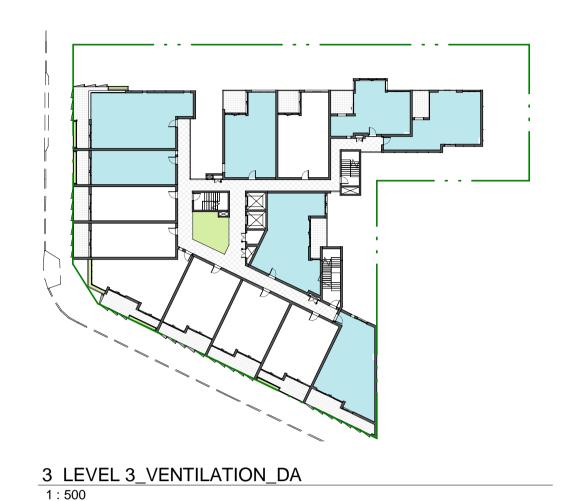
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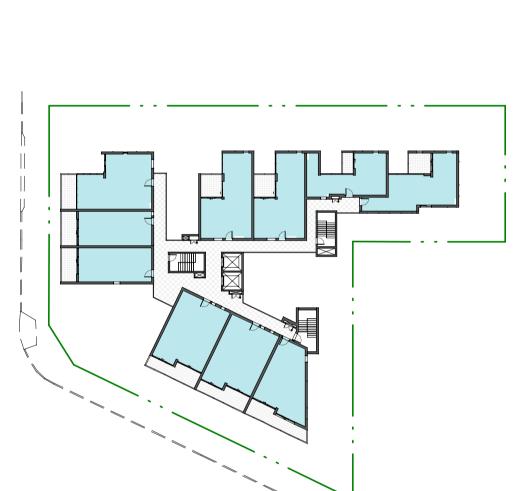
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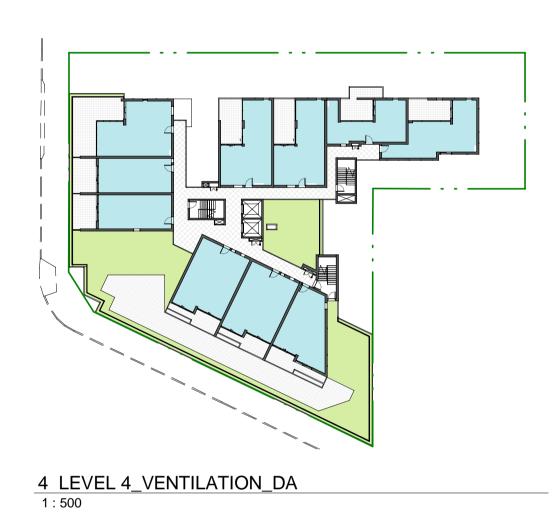






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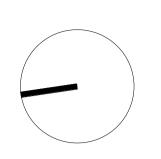




TOTAL NUMBER OF UNITS WITH NATURAL CROSS VENTILATION ACHIEVED = 49 TOTAL NUMBER OF UNITS PROPOSED IN THE DEVELOPMENT = **71** TOTAL PERCENTAGE ACHIEVED = 49 / 71 = 69.01% IMPORTANT NOTES:

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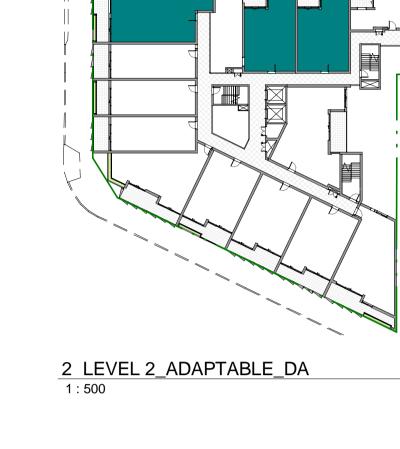
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CROSS VENTILATION SCHEDULE
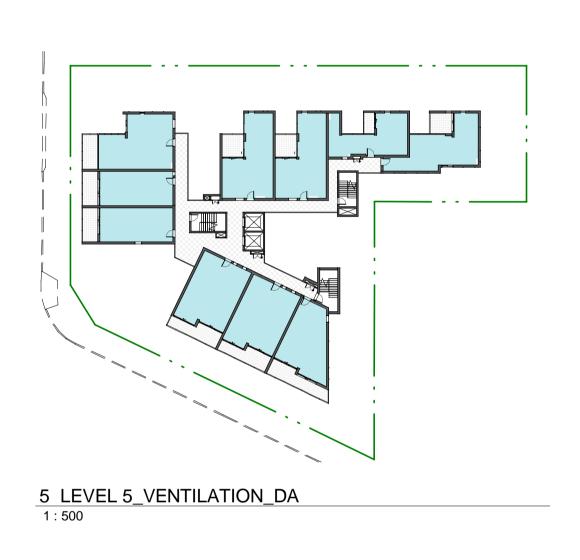
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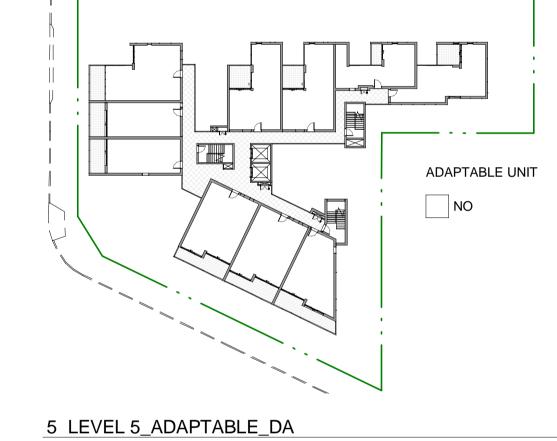


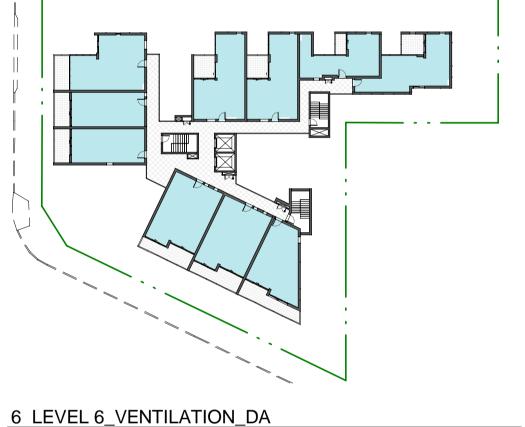



ADAPTABLE UNIT


NO





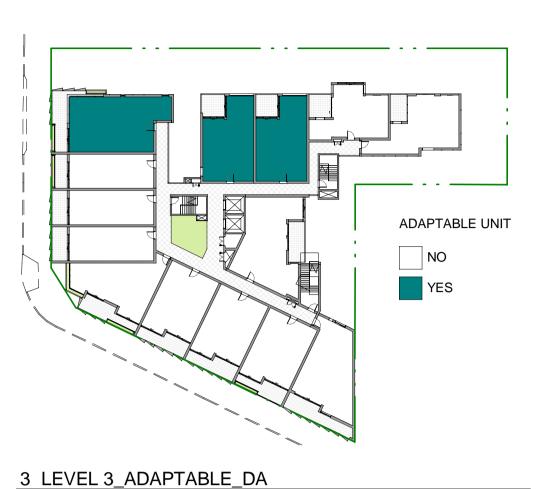

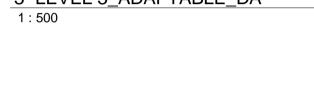

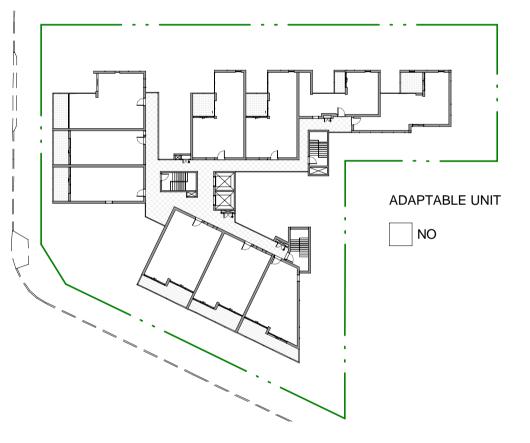

6 LEVEL 6_ADAPTABLE_DA
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ADAPTABLE COMPLIANCE_DA				
ADAPTABLE	Count			
YES	9			
NO	62			

Minimum 10% 9/71 = 12.6%


NOTE: AS ADVISED BY BCA CONSULTANT THAT WE MAY NOT REQUIRE TO PROVIDE ADAPTABLE UNITS IF 20% LIVABLE UNITS ARE PROPOSED.

HOWEVER WE HAVE SHOWN THE FEASIBILITY STUDY OF PROVIDING ADAPTABLE UNIT DESIGN AND IN FUTURE IF IT IS REQUIRED TO ACCOMMODATE THAN WE CAN ACHIEVE THE SAME.

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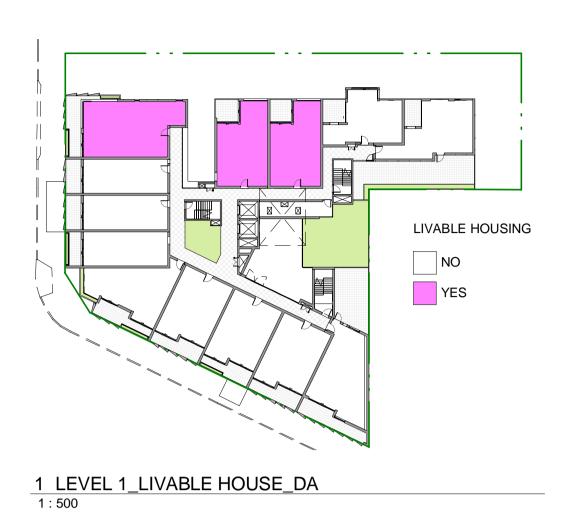



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DRAWING TITLE

ADAPTABLE UNITS SCHEDULE
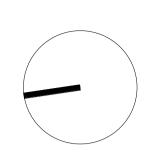
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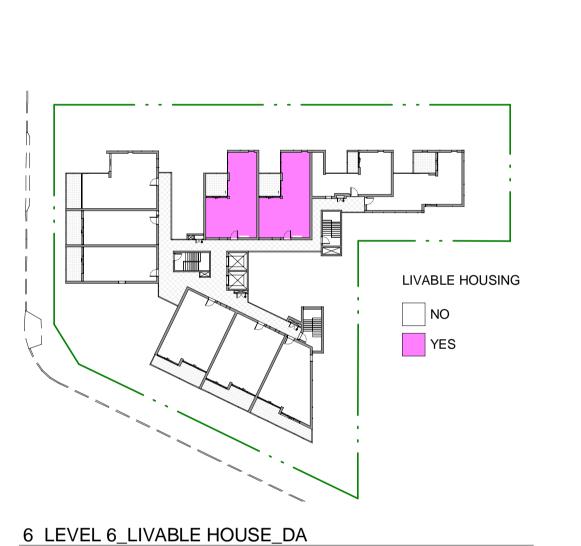






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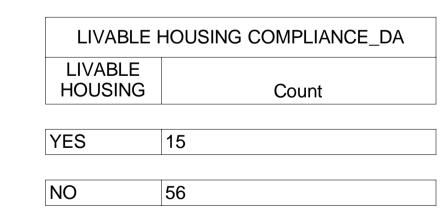

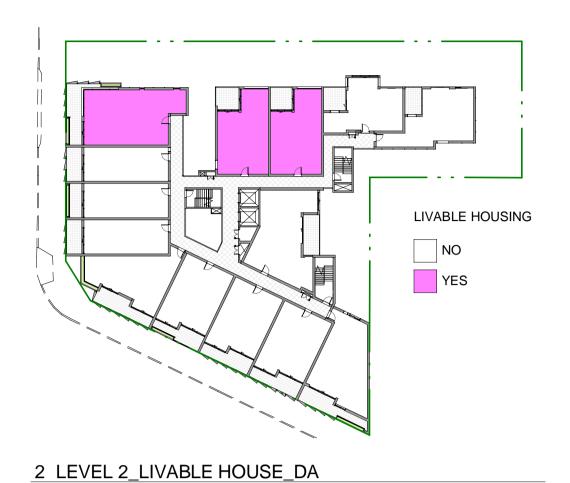
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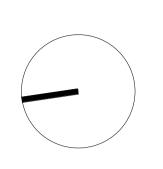




Minimum 20% 15/71 = 21.12% Do not scale from drawings. All dimensions to be checked on site before commencement of work. All discrepancies to be brought to the attention of the Architect. Larger scale drawings and written dimensions take preference. This drawing is copyright and the property of the author, and must not be retained, copied or used without the express authority of MARCHESE + PARTNERS INTERNATIONAL PTY. LTD.

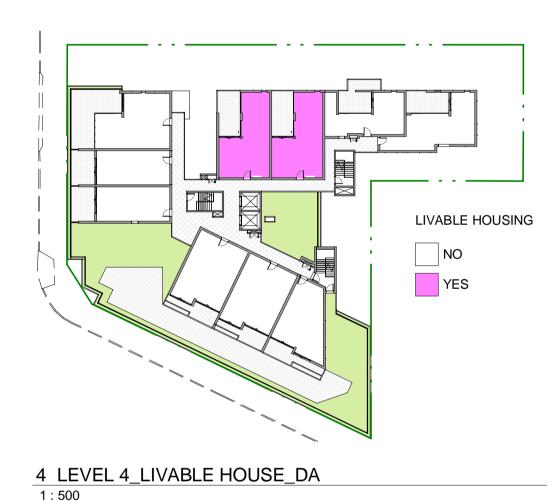IMPORTANT NOTES:
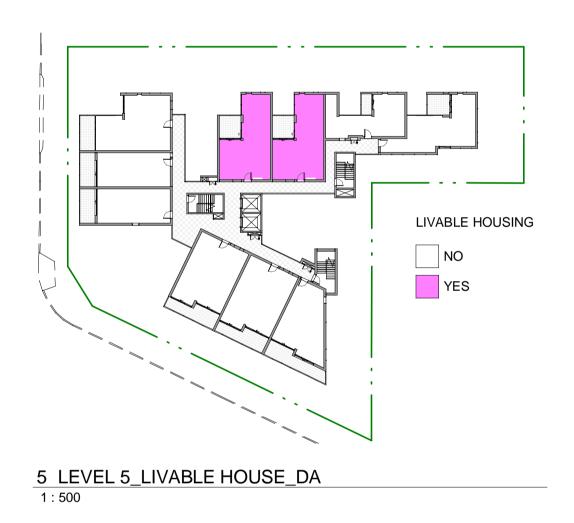
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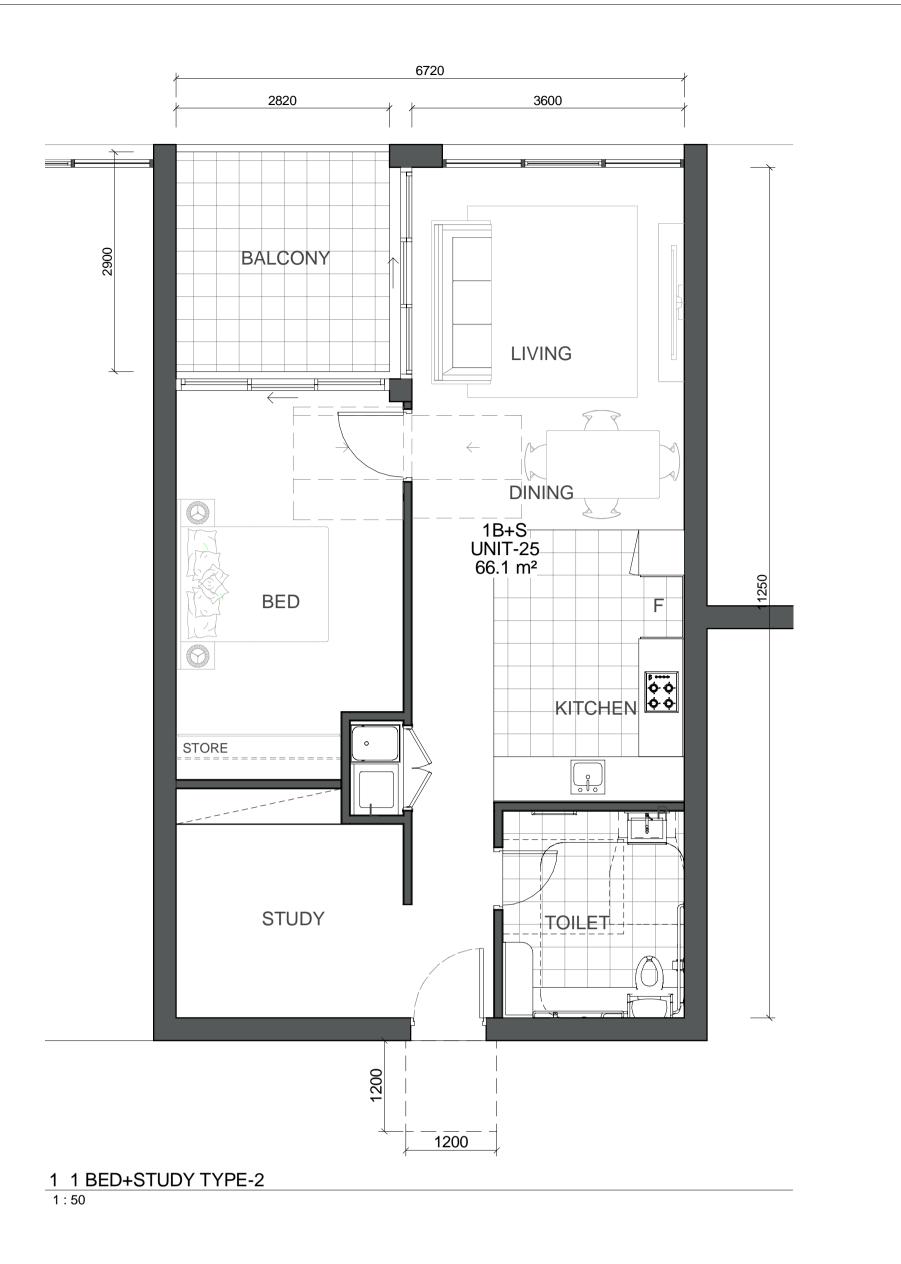
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2 DELMAR PARADE, DEE WHY, NSW

DRAWING TITLE SILVER UNIVERSAL LIVING SCHEDULE

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1:50





PERFORMANCE STATEMENT - THERE IS A SAFE, CONTINUOUS, STEP-FREE PATHWAY FROM THE STREET ENTRANCE AND/OR PARKING AREA TO A DWELLING ENTRANCE THAT IS LEVEL.

SILVER LEVEL A. PROVIDE A SAFE AND CONTINUOUS PATHWAY FROM:

I. THE FRONT BOUNDARY OF THE ALLOTMENT; OR

II. A CAR PARKING SPACE, WHERE PROVIDED, WHICH MAY INCLUDE THE DRIVEWAY ON THE ALLOTMENT, TO AN ENTRANCE THAT IS LEVEL (STEPFREE) AS SPECIFIED IN ELEMENT 2.

THIS PROVISION DOES NOT APPLY WHERE THE AVERAGE SLOPE OF THE GROUND WHERE THE PATH WOULD FEATURE

B. THE PATH OF TRAVEL AS REFERRED TO IN (A) SHOULD HAVE A MINIMUM CLEAR WIDTH OF 1000MM AND -I. AN EVEN, FIRM, SLIP RESISTANT SURFACE;

II. A CROSSFALL OF NOT MORE THAN 1:40;

III. A MAXIMUM PATHWAY SLOPE OF 1:14, WITH LANDINGS PROVIDED AT NO GREATER THAN 9M FOR A 1:14 RAMP AND NO GREATER THAN 15M FOR RAMPS STEEPER THAN 1:20. LANDINGS SHOULD BE NO LESS THAN 1200MM IN LENGTH; AND IV. BE STEP-FREE

C. A STEP RAMP MAY BE INCORPORATED AT AN ENTRANCE DOORWAY WHERE THERE IS A CHANGE IN HEIGHT OF 190MM OR

LESS. THE STEP RAMP SHOULD PROVIDE:

I. A MAXIMUM GRADIENT OF 1:10 II. A MINIMUM CLEAR WIDTH OF 1000MM (PLEASE NOTE: WIDTH SHOULD REFLECT THE PATHWAY WIDTH)

III. A MAXIMUM LENGTH OF 1900MM LEVEL LANDINGS NO LESS THAN 1200MM IN LENGTH, EXCLUSIVE OF THE SWING OF THE DOOR OR GATE THAN OPENS

MUST BE PROVIDED AT THE HEAD AND FOOT OF THE RAMP.

NOTE THE WIDTH OF THE LANDING WILL BE DETERMINED BY THE ADJOINING PATHWAY.

PERFORMANCE STATEMENT - THERE IS AT LEAST ONE LEVEL (STEP-FREE) ENTRANCE INTO THE DWELLING TO ENABLE HOME OCCUPANTS TO EASILY ENTER AND EXIT THE DWELLING. SILVER LEVEL

A. THE DWELLING SHOULD PROVIDE AN ENTRANCE DOOR WITH -

I. A MINIMUM CLEAR OPENING WIDTH OF 820MM (SEE FIGURE 2(A)) II. A LEVEL (STEP-FREE) TRANSITION AND THRESHOLD (MAXIMUM VERTICAL TOLERANCE OF 5MM BETWEEN ABUTTING SURFACES IS ALLOWABLE PROVIDED THE LIP IS ROUNDED OR BEVELED); AND III. REASONABLE SHELTER FROM THE WEATHER.

B. A LEVEL LANDING AREA OF AT LEAST 1200MM X 1200MM SHOULD BE PROVIDED AT THE LEVEL (STEP FREE)

C. WHERE THE THRESHOLD AT THE ENTRANCE EXCEEDS 5MM AND IS LESS THAN 56MM, A RAMPED THRESHOLD MAY BE PROVIDED (SEE FIGURE 1(B)).

D. THE LEVEL (STEP-FREE) ENTRANCE SHOULD BE CONNECTED TO THE SAFE AND CONTINUOUS PATHWAY AS SPECIFIED IN

NOTE THE ENTRANCE MUST INCORPORATE WATERPROOFING AND TERMITE MANAGEMENT REQUIREMENTS AS SPECIFIED IN THE

3. CAR PARKING (WHERE PART OF THE DWELLING ACCESS)

PERFORMANCE STATEMENT - WHERE THE PARKING SPACE IS PART OF THE DWELLING ACCESS IT SHOULD ALLOW A

THEIR CAR DOORS FULLY AND EASILY MOVE AROUND THE VEHICLE. NOT APPLICABLE

4. INTERNAL DOORS & CORRIDORS PERFORMANCE STATEMENT - INTERNAL DOORS AND CORRIDORS FACILITATE COMFORTABLE AND UNIMPEDED MOVEMENT BETWEEN SPACES.

A. DOORWAYS TO ROOMS ON THE ENTRY LEVEL USED FOR LIVING, DINING, BEDROOM, BATHROOM, KITCHEN, LAUNDRY

SANITARY COMPARTMENT PURPOSES SHOULD PROVIDE:

I. A MINIMUM CLEAR OPENING WIDTH OF 820MM (SEE FIGURE 2(A)); AND

II. A LEVEL TRANSITION AND THRESHOLD (MAXIMUM VERTICAL TOLERANCE OF 5MM BETWEEN ABUTTING SURFACES IS ALLOWABLE PROVIDED THE LIP IS ROUNDED OR BEVELED).

B. INTERNAL CORRIDORS/PASSAGEWAYS TO THE DOORWAYS REFERRED TO IN (A) SHOULD PROVIDE A MINIMUM CLEAR WIDTH OF 1000MM.

PERFORMANCE STATEMENT - THE GROUND (OR ENTRY) LEVEL HAS A TOILET TO SUPPORT EASY ACCESS FOR HOME OCCUPANTS AND VISITORS.

A. DWELLINGS SHOULD HAVE A TOILET ON THE GROUND (OR ENTRY) LEVEL THAT PROVIDES: I. A MINIMUM CLEAR WIDTH OF 900MM BETWEEN THE WALLS OF THE BATHROOM IF LOCATED IN A SEPARATE ROOM;

II. A MINIMUM 1200MM CLEAR CIRCULATION SPACE FORWARD OF THE TOILET PAN EXCLUSIVE OF THE SWING OF THE DOOR IN ACCORDANCE WITH FIGURE 3(A).

B. IF THE TOILET IS LOCATED WITHIN THE GROUND (OR ENTRY) LEVEL BATHROOM, THE TOILET PAN SHOULD BE LOCATED IN THE

CORNER OF THE ROOM TO ENABLE THE INSTALLATION OF GRABRAILS.

6. SHOWER

PERFORMANCE STATEMENT - THE BATHROOM AND SHOWER IS DESIGNED FOR EASY AND INDEPENDENT ACCESS FOR ALL HOME **OCCUPANTS**

A. ONE BATHROOM SHOULD FEATURE A SLIP RESISTANT, HOBLESS (STEPFREE) SHOWER RECESS. SHOWER SCREENS

ARE PERMITTED PROVIDED THEY CAN BE EASILY REMOVED AT A LATER DATE. B. THE SHOWER RECESS SHOULD BE LOCATED IN THE CORNER OF THE ROOM TO ENABLE THE INSTALLATION OF GRABRAILS AT A FUTURE DATE.

7. REINFORCEMENT OF BATHROOM & TOILET WALLS

PERFORMANCE STATEMENT - THE BATHROOM AND TOILET WALLS ARE BUILT TO ENABLE GRABRAILS TO BE SAFELY AND ECONOMICALLY INSTALLED. SILVER LEVEL

A. EXCEPT FOR WALLS CONSTRUCTED OF SOLID MASONRY OR CONCRETE, THE WALLS AROUND THE SHOWER, BATH (IF PROVIDED) AND TOILET SHOULD BE REINFORCED TO PROVIDE A FIXING SURFACE FOR THE SAFE INSTALLATION OF GRABRAILS.

B. THE FASTENINGS, WALL REINFORCEMENT AND GRABRAILS COMBINED MUST BE ABLE TO WITHSTAND AT LEAST FORCE APPLIED IN ANY POSITION AND IN ANY DIRECTION. WHEN IT COMES TO ASSESSING THE EXISTENCE OF WALL REINFORCING, THE ASSESSOR HANDBOOK PROVIDES INFORMATION ON A WALL SCANNING DEVICE THAT CAN BE USED

VERIFY THAT REINFORCEMENT EXISTS BEHIND WALL SHEETING. THIS INFORMATION ALONG WITH EVIDENCE SUCH AS

AND DRAWINGS COLLECTED FROM THE BUILDER MAY BE SUFFICIENT TO SATISFY AN ASSESSOR. IT IS ALSO POSSIBLE INSPECTION OF THE WALLS PRIOR TO SHEETING IS NEEDED. ASSESSORS SHOULD DETERMINE THE INSPECTION REQUIREMENTS

FOR AS BUILT INSPECTIONS WITH THEIR CLIENT AND BUILDER AS EARLY IN THE CONSTRUCTION PROCESS AS POSSIBLE. OFTEN

ASKING THE BUILDER TO PHOTOGRAPH THE WALL BEFORE THE SHEETING IS APPLIED IS SUFFICIENT C. THE WALLS AROUND THE TOILET ARE TO BE REINFORCED BY INSTALLING: I. NOGGINGS WITH A THICKNESS OF AT LEAST 25MM IN ACCORDANCE WITH FIGURE 6(A); OR

D. THE WALLS AROUND THE BATH ARE TO BE REINFORCED BY INSTALLING: I. NOGGINGS WITH A THICKNESS OF AT LEAST 25MM IN ACCORDANCE WITH FIGURE 7(A); OR II. SHEETING WITH A THICKNESS OF AT LEAST 12MM IN ACCORDANCE WITH FIGURE 7(B).

II. SHEETING WITH A THICKNESS OF AT LEAST 12MM IN ACCORDANCE WITH FIGURE 6(B).

E. THE WALLS AROUND THE HOBLESS (STEP-FREE) SHOWER RECESS ARE TO BE REINFORCED BY INSTALLING: I. NOGGINGS WITH A THICKNESS OF AT LEAST 25MM IN ACCORDANCE WITH FIGURE 8(A); OR II. SHEETING WITH A THICKNESS OF AT LEAST 12MM IN ACCORDANCE WITH FIGURE 8(B).

PERFORMANCE STATEMENT - WHERE INSTALLED, STAIRWAYS ARE DESIGNED TO REDUCE THE LIKELIHOOD OF INJURY AND ALSO ENABLE FUTURE ADAPTATION.

SILVER LEVEL

A. STAIRWAYS IN DWELLINGS MUST FEATURE:

I. A CONTINUOUS HANDRAIL ON ONE SIDE OF THE STAIRWAY WHERE THERE IS A RISE OF MORE THAN 1M.

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IMPORTANT NOTES:

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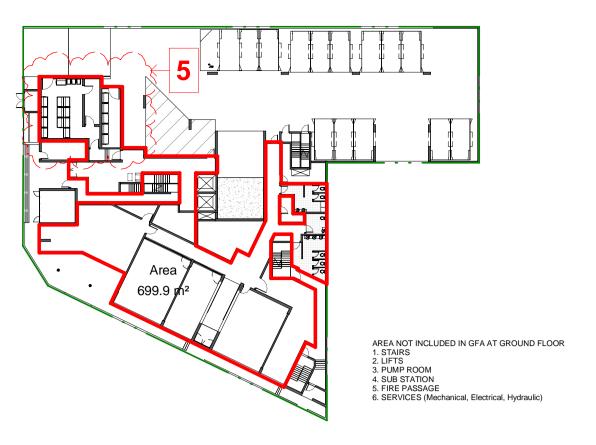
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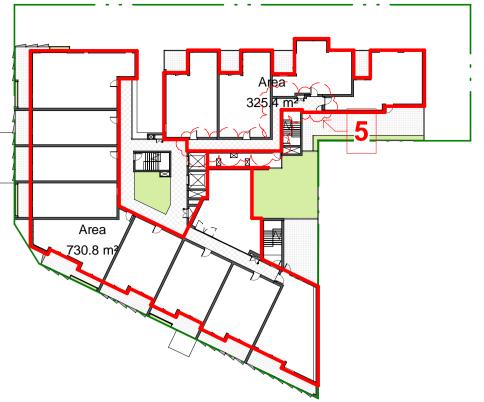
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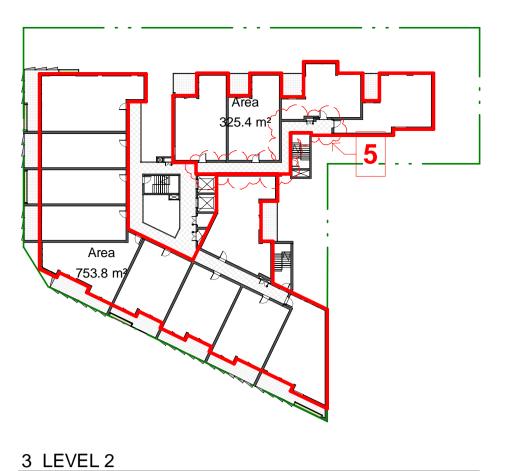
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LIVABLE UNIT PLANS


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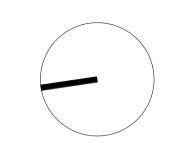
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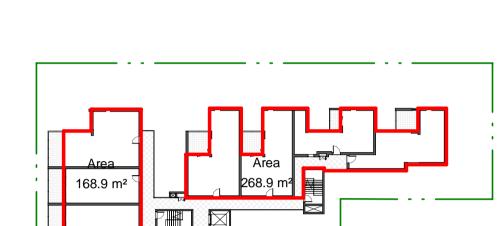


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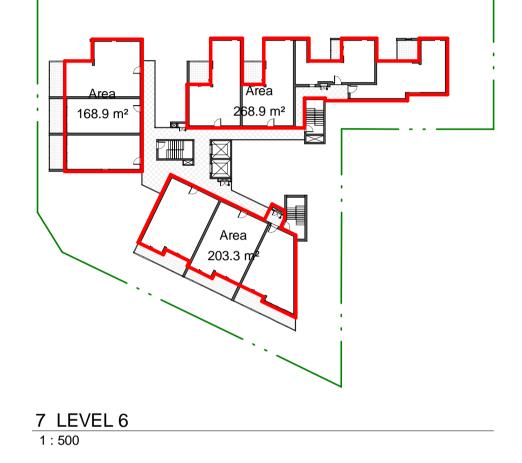
09/07/2018 S34 UPDATE





6 LEVEL 5 1:500

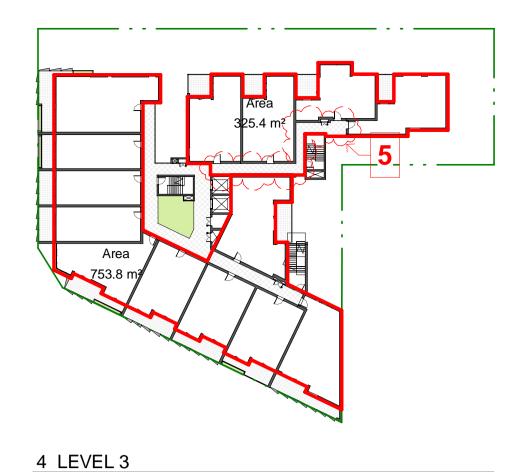



REVISION NOTES: RESPONSE FOR THE DEFERRAL

1 : 500

1. A MINIMUM SETBACK OF 6m FROM THE FRONT SOUTHERN BOUNDARY ABOVE PODIUM LEVEL AND FROM THE REAR SOUTHERN BOUNDARY FROM THE GROUND.

2. IMPROVE ACCESS TO AND QUALITY OF THE COMMUNAL SPEN SPACE AT PODIUM LEVEL, WHICH IS TO BE ACHIEVED BY THE DELETION OF **UNIT 45 AND ABOVE**

3. ANY LIFT TOWERS OR PLANTS BEING CLEARLY SHOWN ON THE PLANS AND NOT TO EXCEED RL 52

4. PROVISION OF DEEP SOIL PLANTING ALONG THE EASTERN BOUNDARY AT GROUND LEVEL TO A MINIMUM AREA OF 5m X 5m

5. RE-CALCULATION OF THE GFA ON THE BASIS THAT GARBAGE FACILITIES NOT IN THE BASEMENT AND CORRIDORS WHICH ARE ENCLOSED ON THEIR LONG SIDE ARE INCLUDED AS FLOOR SPACE.

UNIT INTERNAL AREA			
Level	Name	Area	
LEVEL 1	1B	54.8 m ²	
LEVEL 1	1B+S	63.3 m ²	
LEVEL 1	1B+S	64.6 m ²	
LEVEL 1	1B+S	61.6 m ²	
LEVEL 1	1B+S	61.6 m ²	
LEVEL 1	1B+S	61.6 m ²	
LEVEL 1	1B+S	66.1 m ²	
LEVEL 1	1B+S	66.1 m ²	
LEVEL 1	2B	89.1 m ²	
LEVEL 1	2B	72.9 m ²	
LEVEL 1	STUDIO	50.2 m ²	
LEVEL 1	STUDIO	50.2 m ²	
LEVEL 1	STUDIO	50.2 m ²	

1 GROUND LEVEL

1:500

5 LEVEL 4

	_				
LEVEL 1	1B+S	61.6 m ²	LEVEL 3	1B+S	61.6 m ²
LEVEL 1	1B+S	61.6 m ²	LEVEL 3	1B+S	61.6 m ²
LEVEL 1	1B+S	61.6 m ²	LEVEL 3	1B+S	61.6 m ²
LEVEL 1	1B+S	66.1 m ²	LEVEL 3	1B+S	66.1 m ²
LEVEL 1	1B+S	66.1 m ²	LEVEL 3	1B+S	66.1 m ²
LEVEL 1	2B	89.1 m ²	LEVEL 3	2B	89.1 m ²
LEVEL 1	2B	72.9 m ²	LEVEL 3	2B	72.9 m ²
LEVEL 1	STUDIO	50.2 m ²	LEVEL 3	2B	83.9 m ²
LEVEL 1	STUDIO	50.2 m ²	LEVEL 3	STUDIO	50.2 m ²
LEVEL 1	STUDIO	50.2 m ²	LEVEL 3	STUDIO	50.2 m ²
			LEVEL 3	STUDIO	50.2 m ²
LEVEL 2	1B	54.8 m ²			
LEVEL 2	1B+S	63.3 m ²	LEVEL 4	1B	50.5 m ²
LEVEL 2	1B+S	64.6 m ²	LEVEL 4	1B	57.4 m ²
LEVEL 2	1B+S	61.6 m ²	LEVEL 4	1B	54.5 m ²
LEVEL 2	1B+S	61.6 m ²	LEVEL 4	1B	57.4 m ²
LEVEL 2	1B+S	61.6 m ²	LEVEL 4	1B+S	61.6 m ²
LEVEL 2	1B+S	66.1 m ²	LEVEL 4	1B+S	61.6 m ²
LEVEL 2	1B+S	66.1 m ²	LEVEL 4	1B+S	61.6 m ²
LEVEL 2	2B	89.1 m ²	LEVEL 4	STUDIO	43.4 m ²
LEVEL 2	2B	72.9 m ²	LEVEL 4	STUDIO	43.4 m ²
LEVEL 2	2B	83.9 m ²	LEVEL 4	STUDIO	44.4 m ²
LEVEL 2	STUDIO	50.2 m ²			
LEVEL 2	STUDIO	50.2 m ²	LEVEL 5	1B	50.5 m ²
LEVEL 2	STUDIO	50.2 m ²			

			7
UNIT	INTERNAL	AREA	
Level	Name	Area	
LEVEL 3	1B	54.8 m ²	L
LEVEL 3	1B+S	63.3 m ²	L
LEVEL 3	1B+S	64.6 m ²	L
LEVEL 3	1B+S	61.6 m ²	L
LEVEL 3	1B+S	61.6 m ²	L
LEVEL 3	1B+S	61.6 m ²	L
LEVEL 3	1B+S	66.1 m ²	L
LEVEL 3	1B+S	66.1 m ²	L
LEVEL 3	2B	89.1 m ²	L
LEVEL 3	2B	72.9 m ²	
LEVEL 3	2B	83.9 m ²	L
LEVEL 3	STUDIO	50.2 m ²	L
LEVEL 3	STUDIO	50.2 m ²	L
LEVEL 3	STUDIO	50.2 m ²	L
			L
LEVEL 4	1B	50.5 m ²	L
LEVEL 4	1B	57.4 m ²	L
LEVEL 4	1B	54.5 m ²	L
LEVEL 4	1B	57.4 m ²	L
LEVEL 4	1B+S	61.6 m ²	L
LEVEL 4	1B+S	61.6 m ²	
			-1

Level	Name	Area
LEVEL 5	1B	57.4 m ²
LEVEL 5	1B	54.4 m ²
LEVEL 5	1B	57.4 m ²
LEVEL 5	1B+S	61.6 m ²
LEVEL 5	1B+S	61.6 m ²
LEVEL 5	1B+S	61.6 m ²
LEVEL 5	STUDIO	44.4 m ²
LEVEL 5	STUDIO	43.4 m ²
LEVEL 5	STUDIO	43.4 m ²
	•	
LEVEL 6	1B	50.5 m ²
LEVEL 6	1B	57.4 m ²
LEVEL 6	1B	54.4 m ²
LEVEL 6	1B	57.4 m ²
LEVEL 6	1B+S	61.6 m ²
LEVEL 6	1B+S	61.6 m ²
LEVEL 6	1B+S	61.6 m ²
LEVEL 6	STUDIO	44.4 m ²
LEVEL 6	STUDIO	43.4 m ²
LEVEL 6	STUDIO	43.4 m ²

UNIT T		
Level	Name	Count
15/514	4.0	
LEVEL 1	1B	1
LEVEL 1	1B+S	7
LEVEL 1	2B	2
LEVEL 1	STUDIO	3
	4 D	13
LEVEL 2	1B	1
LEVEL 2	1B+S	7
LEVEL 2	2B	3
LEVEL 2	STUDIO	14
LEVEL 3	1B	
	+	7
LEVEL 3	1B+S 2B	
LEVEL 3		3
LEVEL 3	STUDIO	3 14
LEVEL 4	1B	4
LEVEL 4	1B+S	3
LEVEL 4	STUDIO	3
LEVEL 4	310010	10
LEVEL 5	1B	4
LEVEL 5	1B+S	3
LEVEL 5	STUDIO	3
	310010	10
LEVEL 6	1B	4
LEVEL 6	1B+S	3
LEVEL 6	STUDIO	3
	313513	10
Grand tota	\I	71

vei	ivame	Count		Levei		name	Ai
	•						
EL 1	1B	1		GROUND LEVEL	CO	MMERCIAL	59.6
EL 1	1B+S	7		GROUND LEVEL	CO	MMERCIAL	64.9
EL 1	2B	2		GROUND LEVEL	CO	MMERCIAL	39.8
EL 1	STUDIO	3		GROUND LEVEL	CO	MMERCIAL	65.2
		13		GROUND LEVEL	RE	TAIL_CAFE	76.3
EL 2	1B	1					305.7
EL 2	1B+S	7		\ \\\\\\\\\\\\\\\\\\\\\\\\\\\\\\\\\\\\	~ ~	~	~ ~
EL 2	2B	3		GFA CA		ΛΤΙΩΝΙ	
EL 2	STUDIO	3					
		14		Level		Area	
EL 3	1B	1	}				
EL 3	1B+S	7	\	GROUND LEVEL		9.9 m²	
EL 3	2B	3		LEVEL 1)56.1 m ²	
EL 3	STUDIO	3	}	LEVEL 2		79.2 m ²	
		14		LEVEL 3		79.2 m ²	
EL 4	1B	4		LEVEL 4		1.1 m ²	
EL 4	1B+S	3		LEVEL 5		1.1 m ²	
EL 4	STUDIO	3		LEVEL 6	64	1.1 m ²	
		10	<u> </u>	Grand total	58	37.6 m²	
EL 5	1B	4			1		
EL 5	1B+S	3		UNI	T YIE	ELD	
EL 5	STUDIO	3					
		10	_	Unit Type		Coun	τ
EL 6	1B	4		4D		15	
EL 6	1B+S	3		1B		15	
=1 6	STUDIO	3		1B+S		30	

RETAIL AREA SCHEDULE				PARKING SCHEDULE		
Level Name		Area		Level Co		
	•		•			
JND LEVEL	COMMERCIAL	59.6 m ²		BASEMENT 2	48	
JND LEVEL	COMMERCIAL	64.9 m ²		BASEMENT 1	47	
JND LEVEL	COMMERCIAL	39.8 m ²		GROUND LEVEL	14	
JND LEVEL	COMMERCIAL	65.2 m ²		Grand total	109	
JND LEVEL	RETAIL_CAFE	76.3 m ²				
	-	305.7 m ²	•			

GFA CALCULATION		
Level	Area	
GROUND LEVEL	699.9 m ²	
LEVEL 1	1056.1 m ²	
LEVEL 2	1079.2 m²	
LEVEL 3	1079.2 m²	
LEVEL 4	641.1 m ²	
LEVEL 5	641.1 m ²	
LEVEL 6	641.1 m ²	
Grand total	5837.6 m ²	
mmm		

UNIT YIELD			
Unit Type	Count		
1B	15		
1B+S	30		
2B	8		
STUDIO	18		
Grand total	71		

PARKING SCH	IEDULE
Level	Count
BASEMENT 2	48
BASEMENT 1	47
GROUND LEVEL	14
Grand total	109

PARKING REQUIRED AS PER COUNCIL: $1 \times STUDIO = 1 \times 18 = 18$

1 x 1 BED = 1x15 = 15 $1 \times 1 \text{ BED+S} = 1 \times 30 = 30$ $1.2 \times 2 BED = 1.2 \times 08 = 10$

TOTAL FOR RESIDENCE = 73

1 VISITOR PER 5 UNITS = 15

5 CAR PARKING FOR RETAIL- (CAFETERIA) = 8 1 COMMERCIAL PARKING PER 40 m² = 6

TOTAL CAR PARK REQUIRED = 73+15+8+6 = 102

TOTAL CAR PARK REQUIRED = 102 **TOTAL CAR PARK PROVIDED = 109**

TOTAL TENDUM CAR PARKS = 04 (FOR RESIDENTS IN BASEMENT) TOTAL 2 ACCISSIBLE VISIOTR CAR PARK PROVIDED. ONE FOR RETAIL AND ONE FOR RESIDENCE

TOTAL NUMBER OF BICYCLE SPACE = 80 IN BASEMENT-2

PLOT AREA: 2060 m² TOTAL GFA ALLOWED = 2060 x 3.2 = 6592 m²

PROPOSED GFA = 5837.6 m² CURRENT FSR = 2.83:1

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DRAWING TITLE

FSR CALCULATIONS

SCALE	DATE	DRAWN	CHECKED
As indicated @A1	09/07/2018	PM	PD
JOB	DRAWING		REVISION
17079	DA9-05		2








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DEVELOPMENT APPLICATION

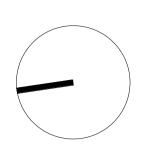

 REVISION
 DATE
 DESCRIPTION
 BY

 1
 01/12/2017
 DEVELOPMENT APPLICATION
 PM

 2
 09/07/2018
 S34 UPDATE
 PM

STORAGE REQUIRED AS PER COUNCIL: 4 x STUDIO = 4x18 = 72 6 x 1 BED = 6x15 = 90 6 x 1 BED+S = 6x30 = 180 8 x 2 BED = 8x08 = 64

TOTAL FOR STORAGE REQUIED FOR RESIDENCE = 406

TOTAL STORAGE PROVIDED = 649.25 sq.m

TOTAL STORAGE PROVIDED AT BASEMENT 1 &2 = 334.54 sq.m.

TOTAL STORAGE PROVIDED AT RESIDENTIAL UNITS = 314.71 sq.m.

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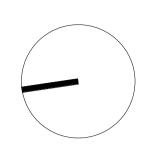
STORAGE PLAN B2 - L2

SCALE 1 : 200 @A1	DATE	DRAWN	CHECKED	
	09/07/2018	PM	PD	
ов 1 7079	DA9-08		REVISION 2	



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DEVELOPMENT **APPLICATION**



REVISION DATE DESCRIPTION 01/12/2017 DEVELOPMENT APPLICATION 09/07/2018 S34 UPDATE

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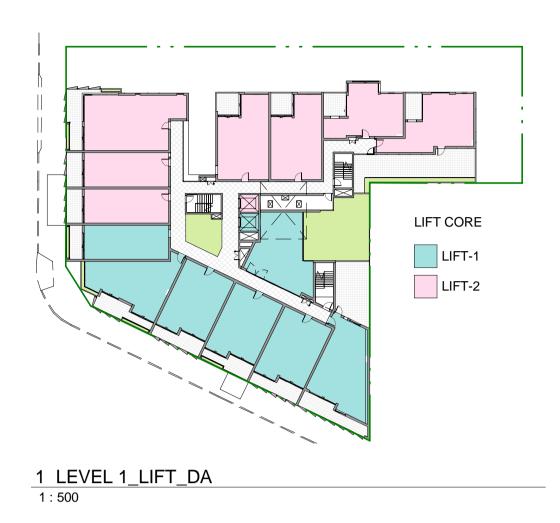


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DRAWING TITLE

STORAGE PLAN L3 - L6

SCALE 1 : 200 @A1	DATE	DRAWN	CHECKED	
	09/07/2018	PM	PD	
ов 1 7079	DA9-09		REVISION 2	




4 LEVEL 4_LIFT_DA 1:500


LIFT CORE


LIFT-2

LIFT-1



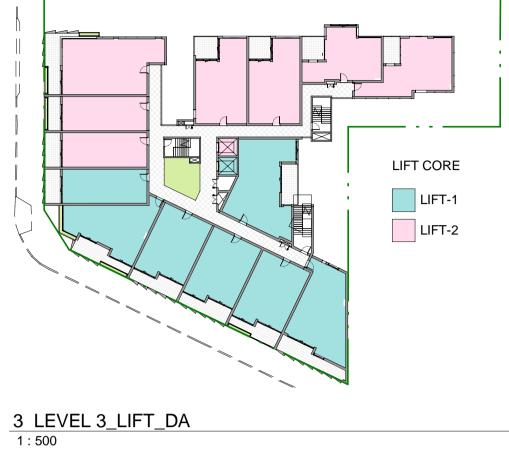

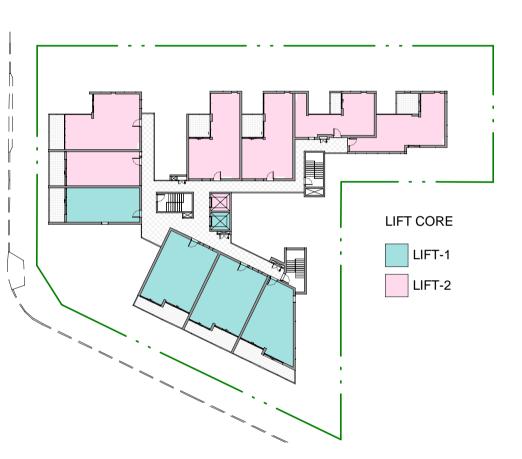

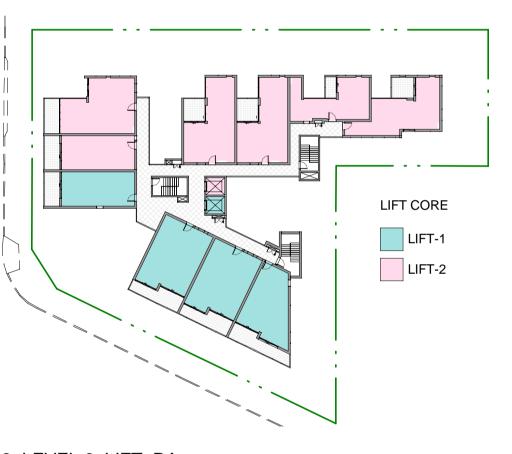

	LIFT CORE LIFT-1 LIFT-2	
5 LEVEL 5_LIFT_DA 1:500		6 LEVEL 6_LIFT_DA 1:500

BUILDING C	ORE COMP	PLIANCE (TABLE 2)
BUILDING CORE	Level	Count
LIFT-1	LEVEL 1	6
LIFT-1	LEVEL 2	7
LIFT-1	LEVEL 3	7
LIFT-1	LEVEL 4	4
LIFT-1	LEVEL 5	4
LIFT-1	LEVEL 6	4
		32
LIFT-2	LEVEL 1	7
LIFT-2	LEVEL 2	7
LIFT-2	LEVEL 3	7
LIFT-2	LEVEL 4	6
LIFT-2	LEVEL 5	6
LIFT-2	LEVEL 6	6
	,	39
Grand total: 7	1	71

BUILDING	CORE CO	MPL
BUILDING CORE	Level	(
LIFT-1	LEVEL 1	6
LIFT-2	LEVEL 1	7
		13
LIFT-1	LEVEL 2	7
LIFT-2	LEVEL 2	7
		14
LIFT-1	LEVEL 3	7
LIFT-2	LEVEL 3	7
		14
LIFT-1	LEVEL 4	4
LIFT-2	LEVEL 4	6
		10

LEVEL 5 4

LEVEL 5 6

LEVEL 6 4 LEVEL 6 6


Grand total: 71

Level	Count	Marchese Partners International Pty Ltd Unit 2 Level 6, 15 London Circuit Canberra, ACT 2601. Australia
LEVEL 1	6	P +61 2 6257 1400 F +61 2 6257 4319
LEVEL 1	7	E info@marchesepartners.com www.marchesepartners.com
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LEVEL 2	7	ACN 20 098 552 151
LEVEL 2	7	
	14	CLIENT
LEVEL 3	7	GANNET GANNET
LEVEL 3	7	DEVELOPMENTS
	14	DEVELOT WILINTS
		PROJECT

2 DELMAR PARADE, DEE WHY, NSW
DRAWING TITLE

LIFT CORE DIAGRAM

SCALE	DATE	DRAWN	CHECKED	
1 : 500 @A1	09/07/2018	PM	PD	
JOB	DRAWING		REVISION	
17079	DA9-10		2	

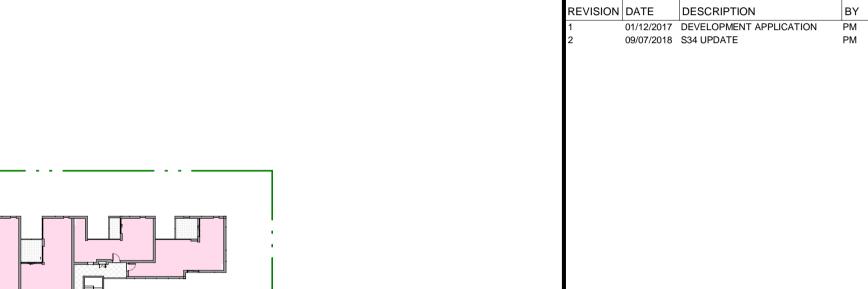


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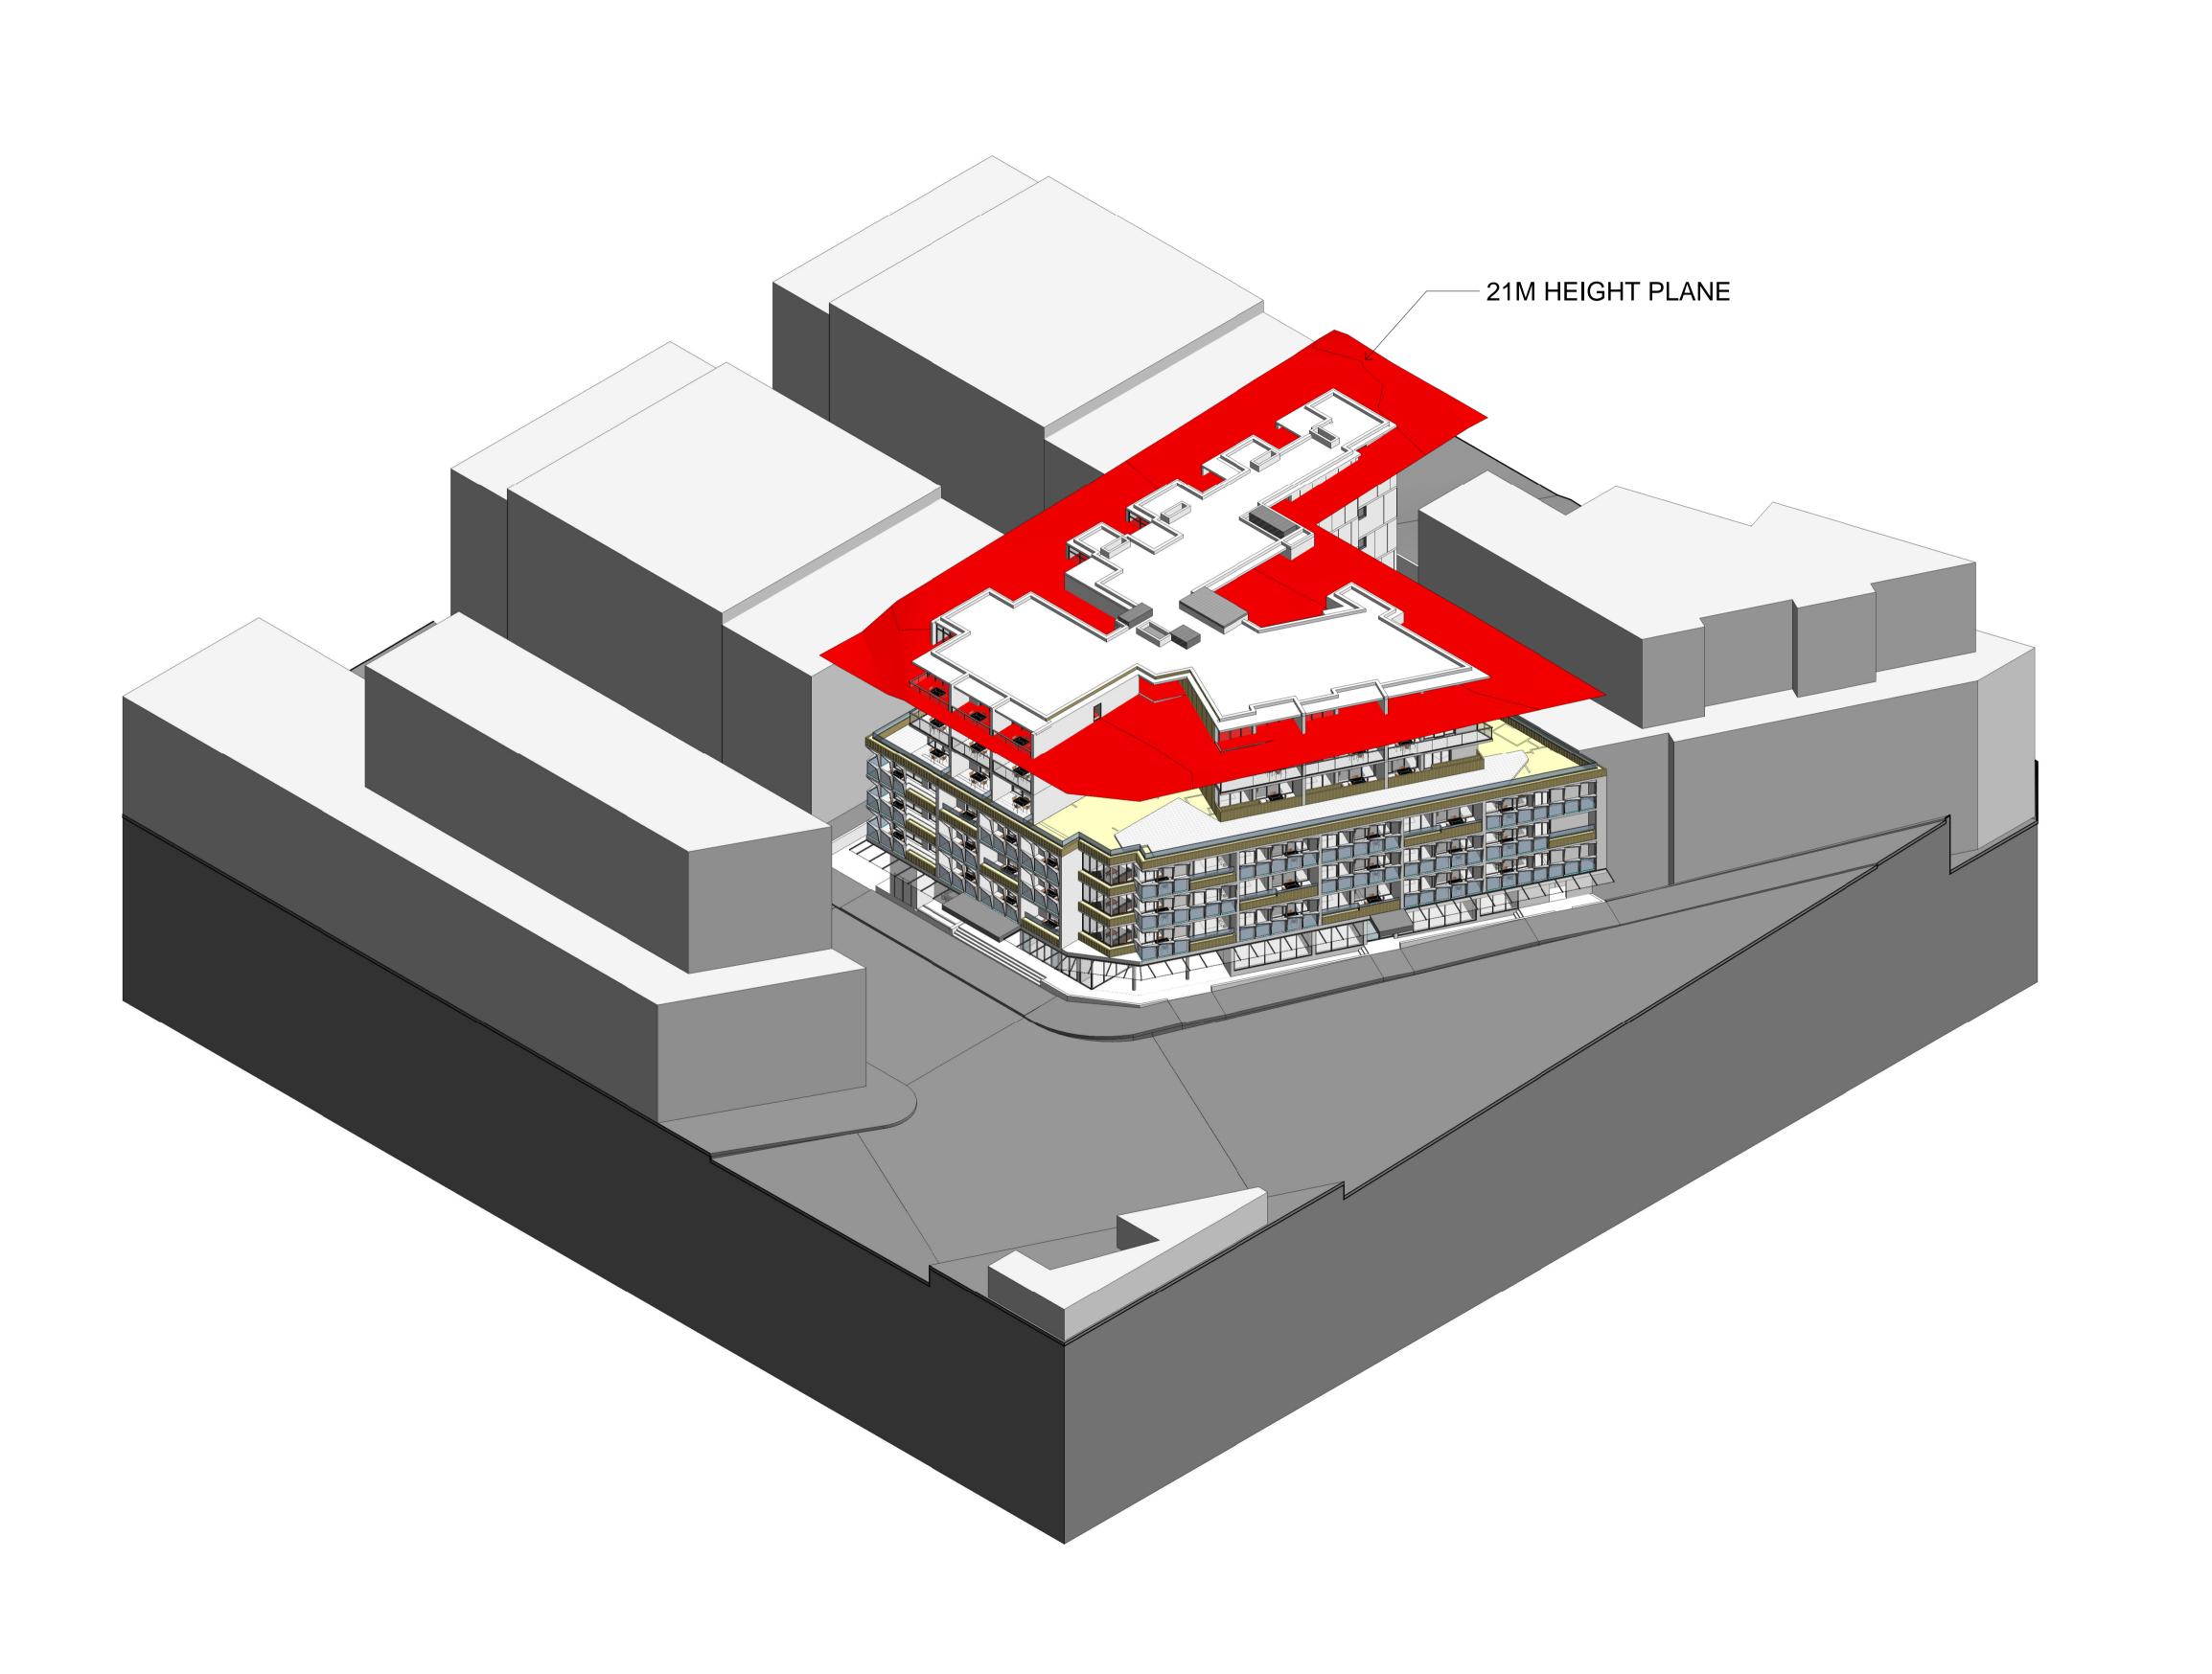


2 DELMAR PARADE, DEE WHY, NSW

DRAWING TITLE

24m HEIGHT PLANE DIAGRAM

SCALE @A1	DATE 09/07/2018	drawn PM	CHECKED PD
ЈОВ 17079	DRAWING DA9-11		REVISION 2

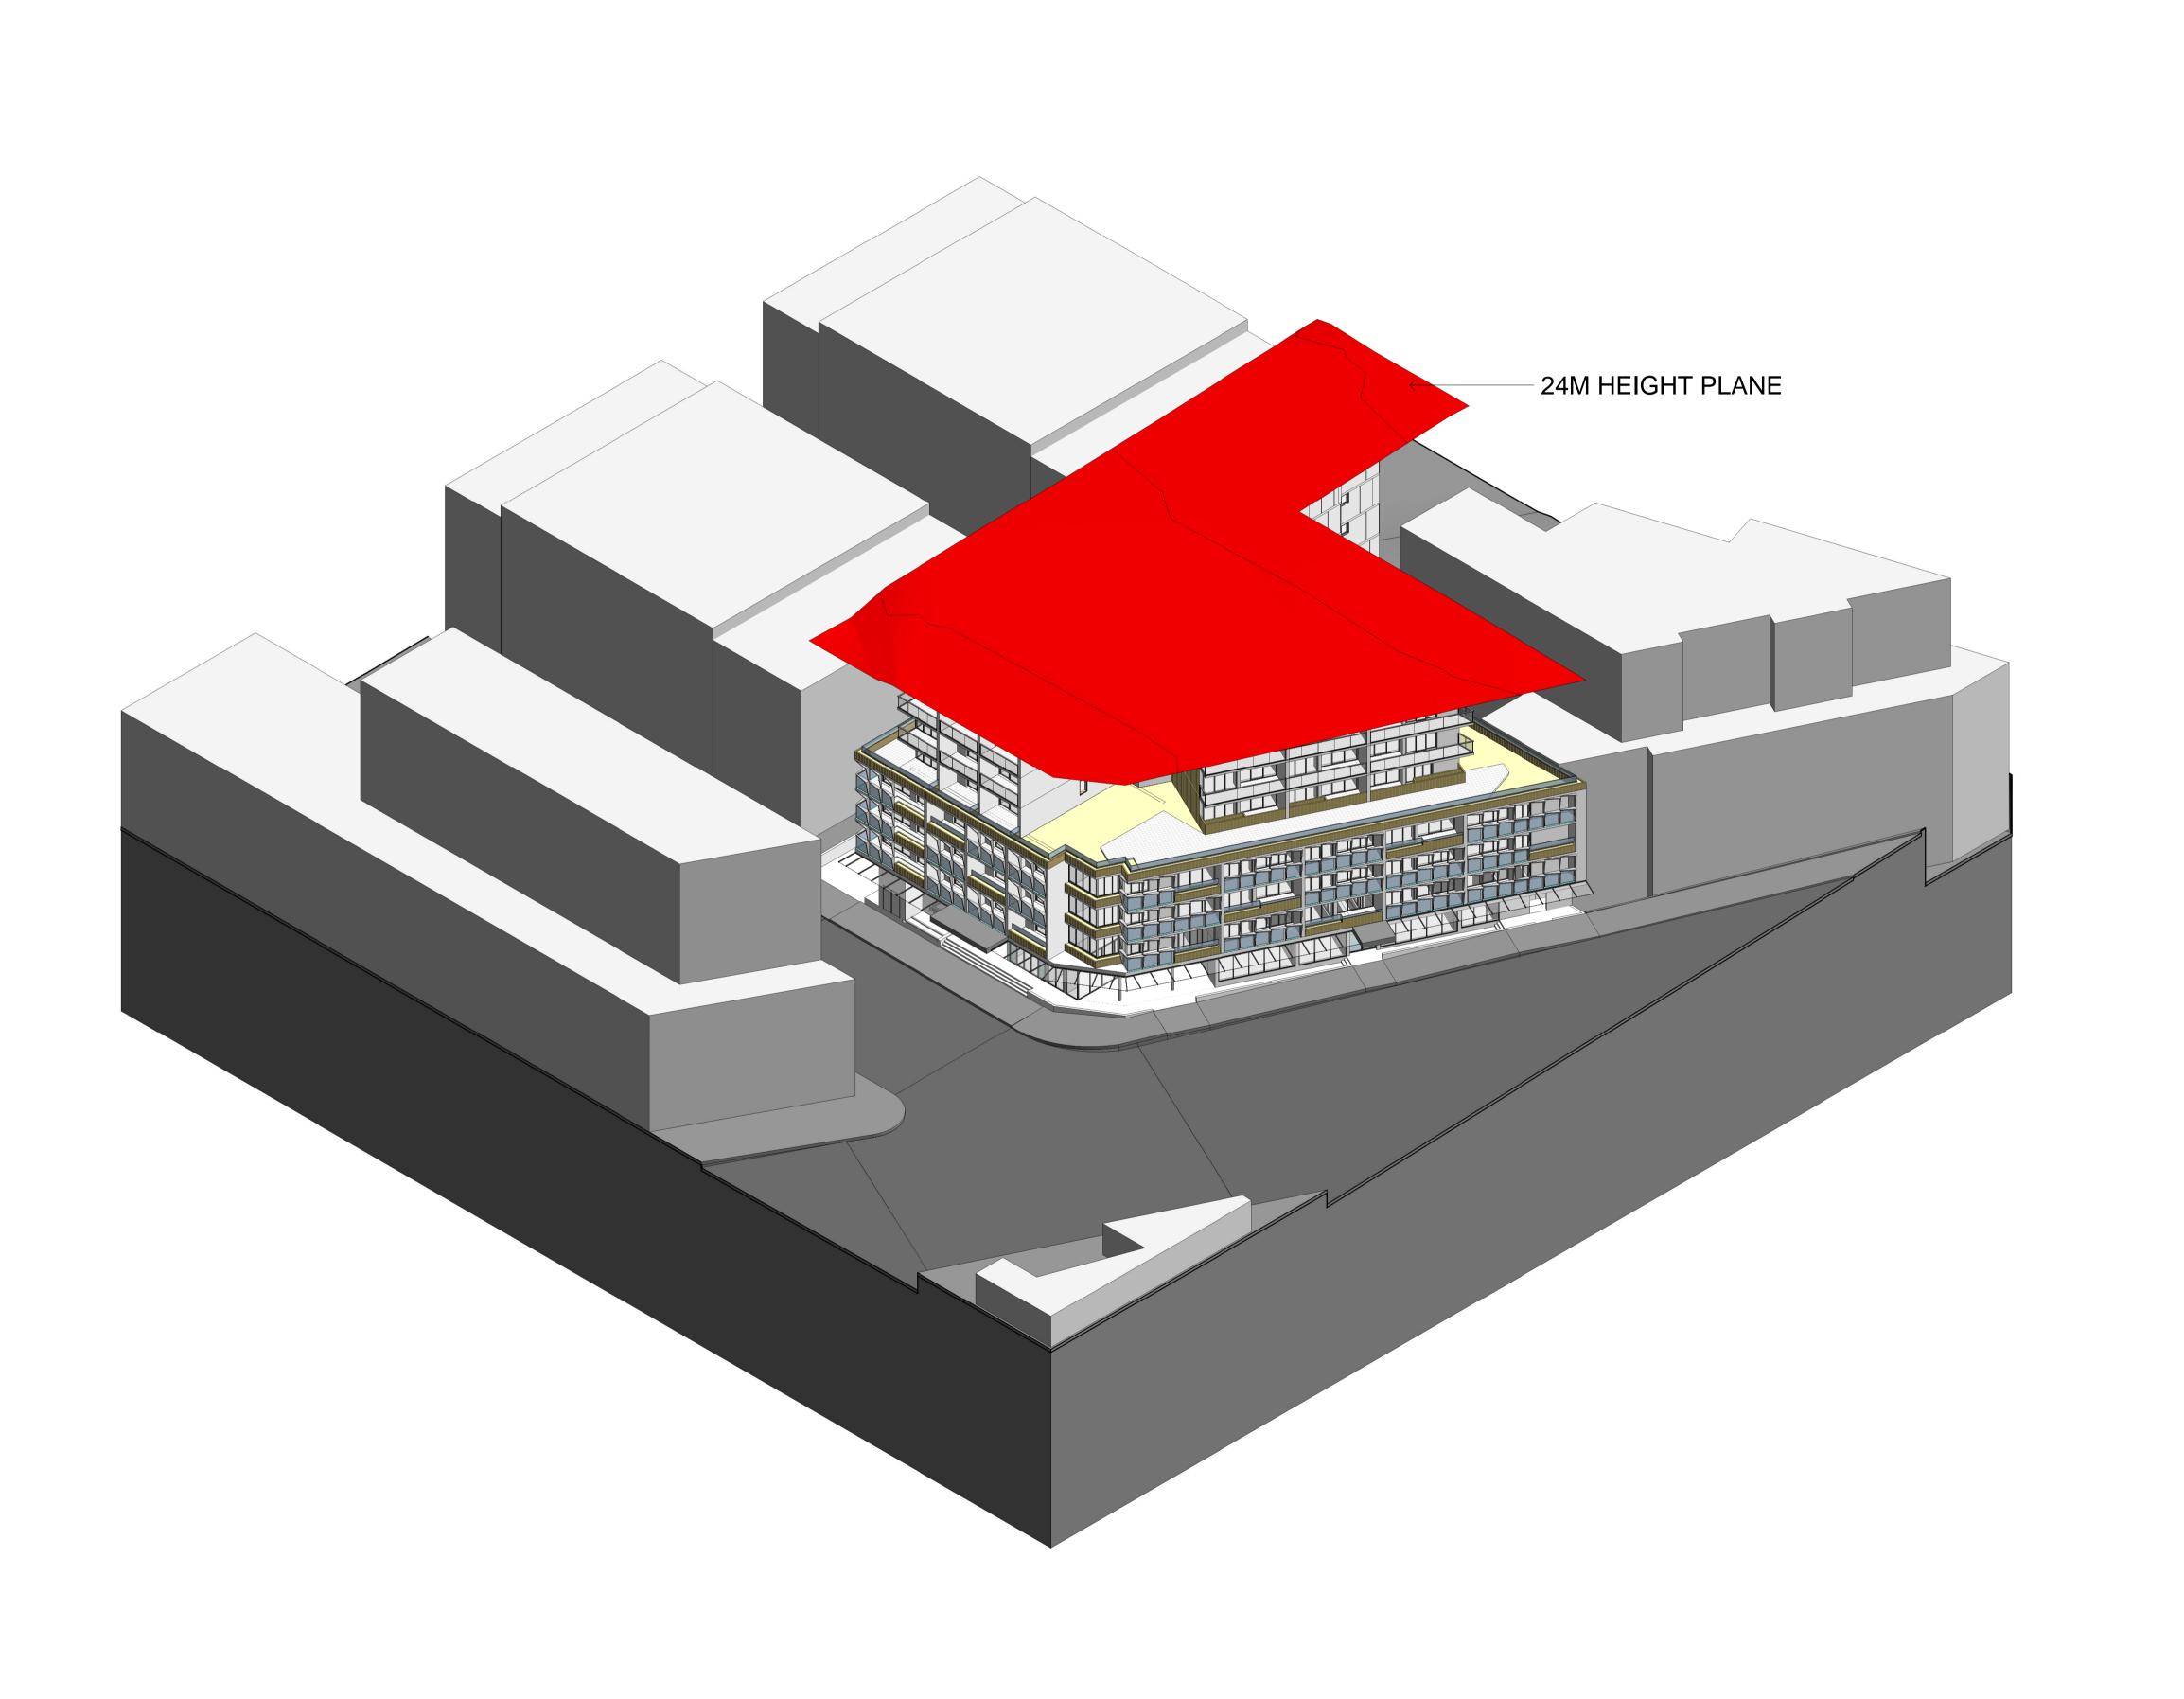

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04/04/2018 MKT_REV 1 PD 01/12/2017 DEVELOPMENT APPLICATION PM 09/07/2018 S34 UPDATE

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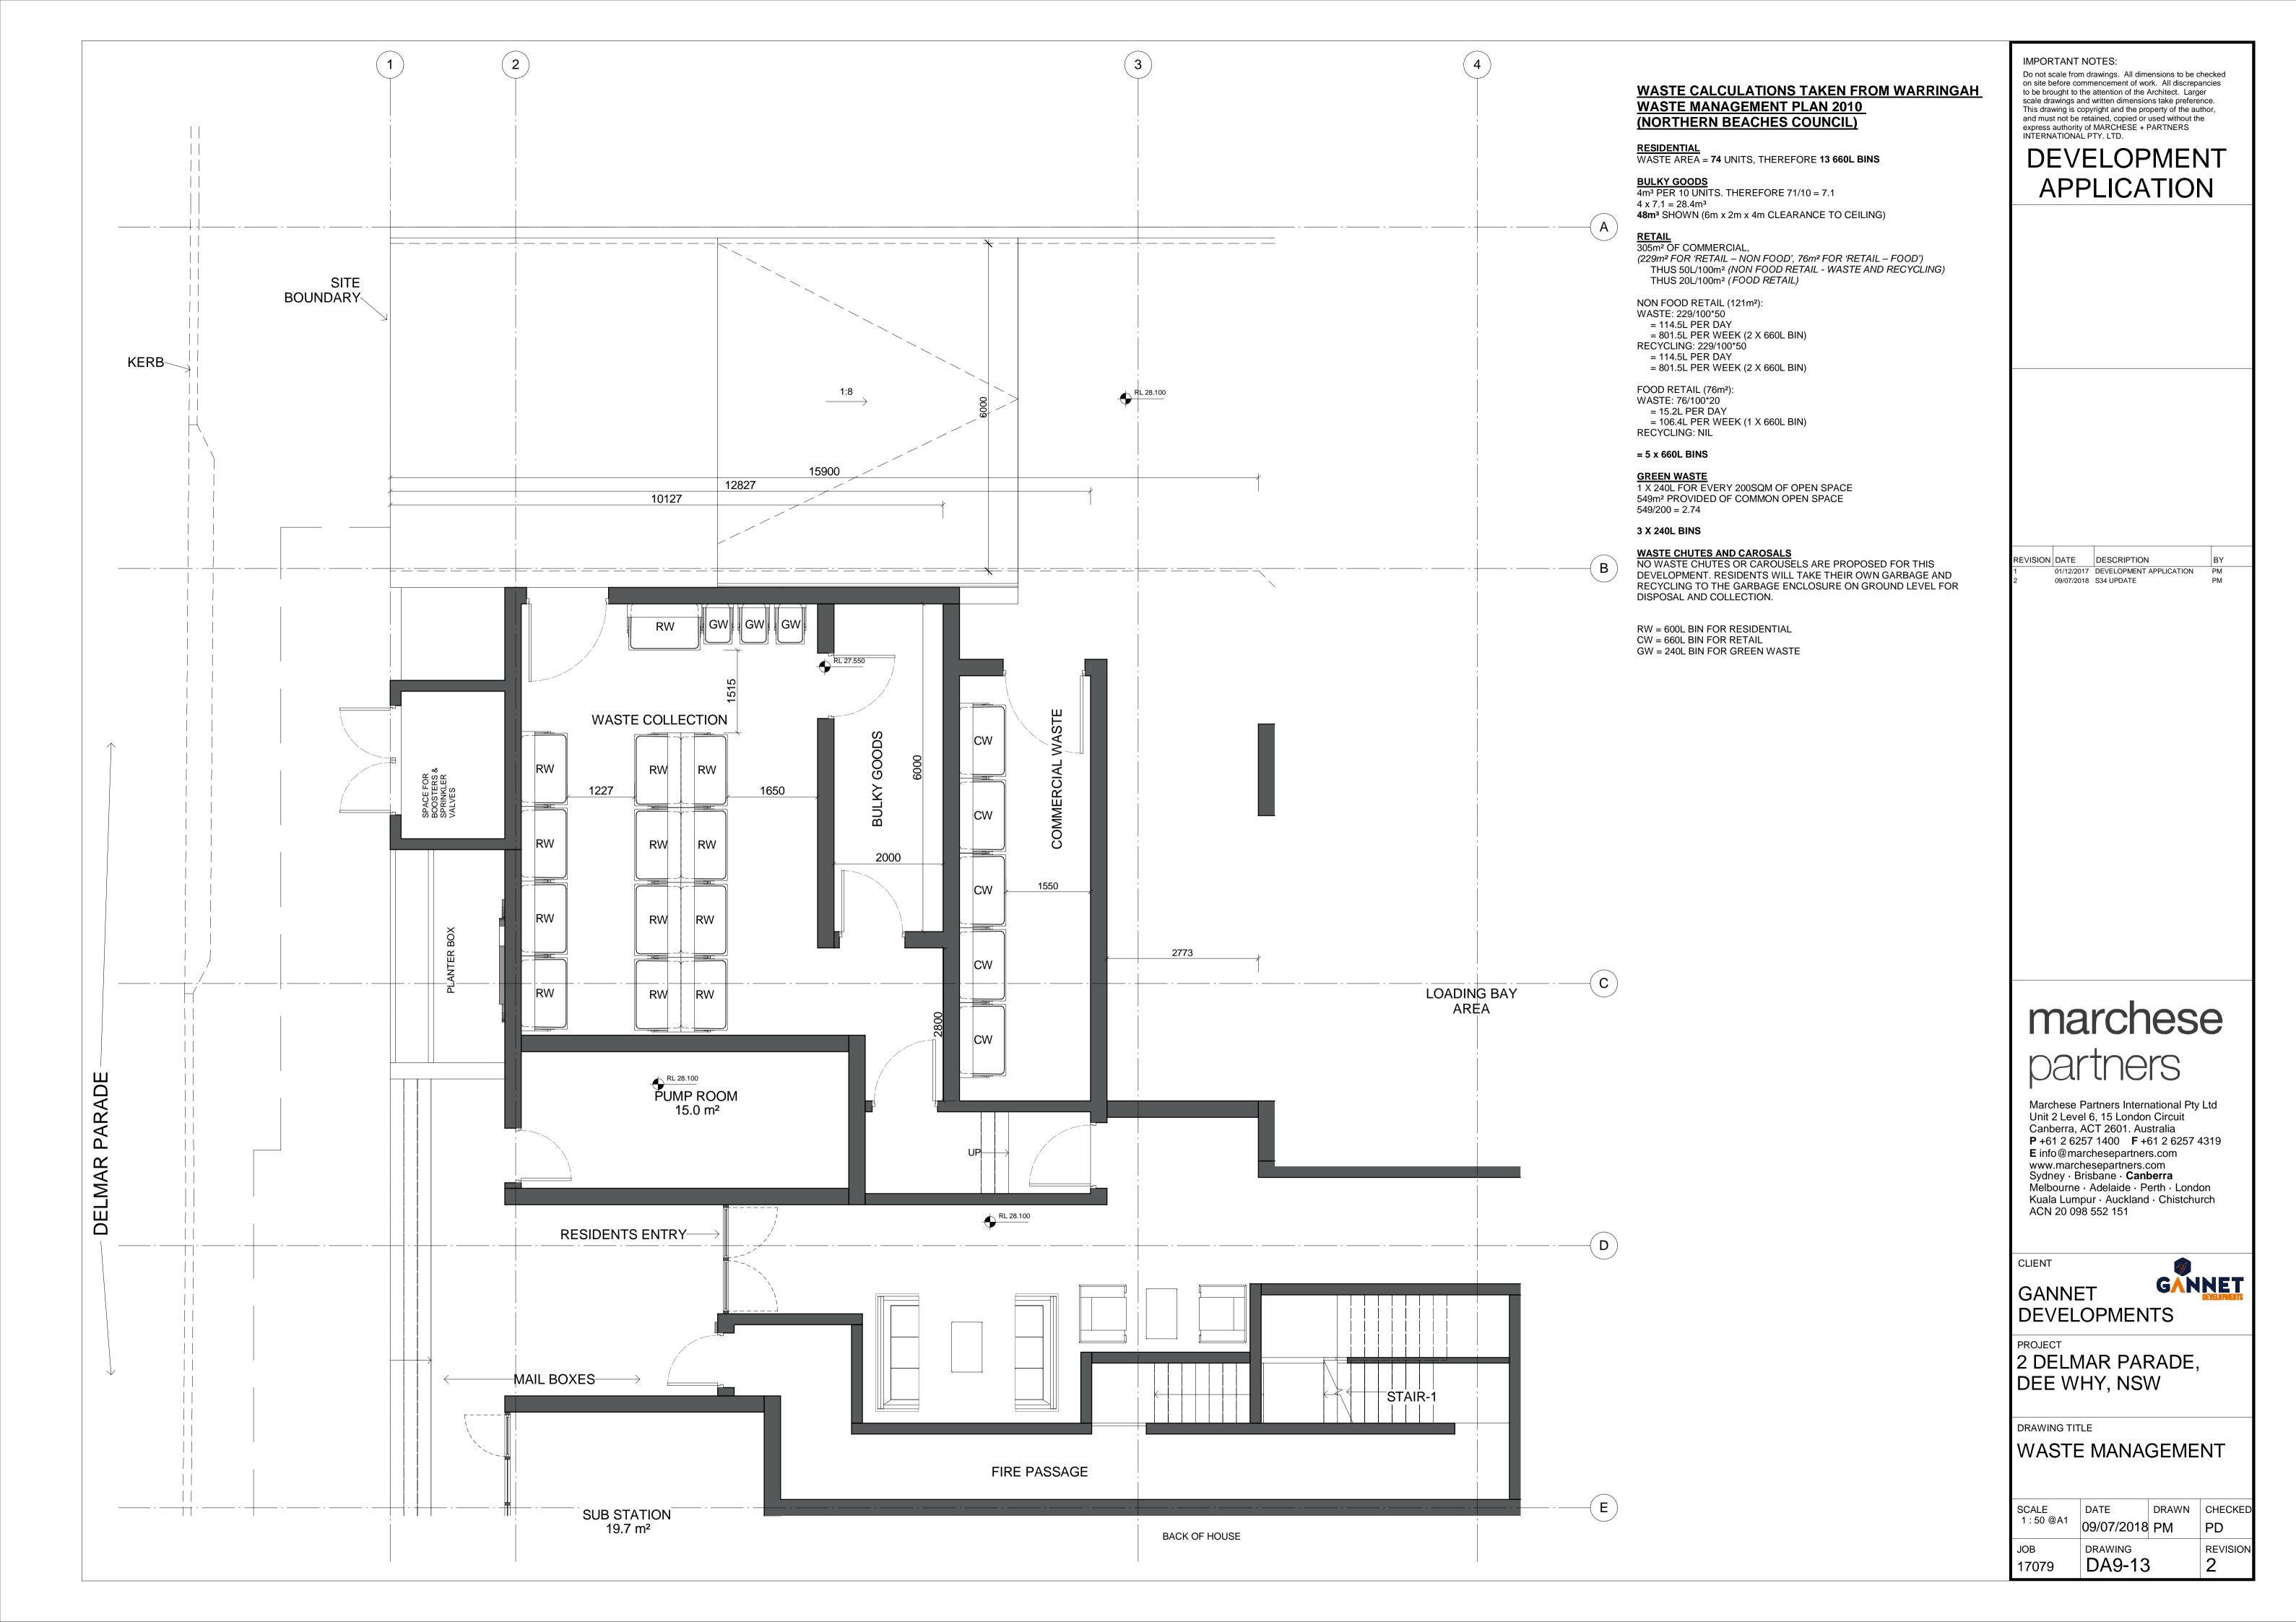



2 DELMAR PARADE,

DEE WHY, NSW

DRAWING TITLE 21m HEIGHT PLANE DIAGRAM


SCALE	DATE	DRAWN	CHECKED
@A1	09/07/2018	PM	PD
_{ЈОВ} 17079	DA9-12		



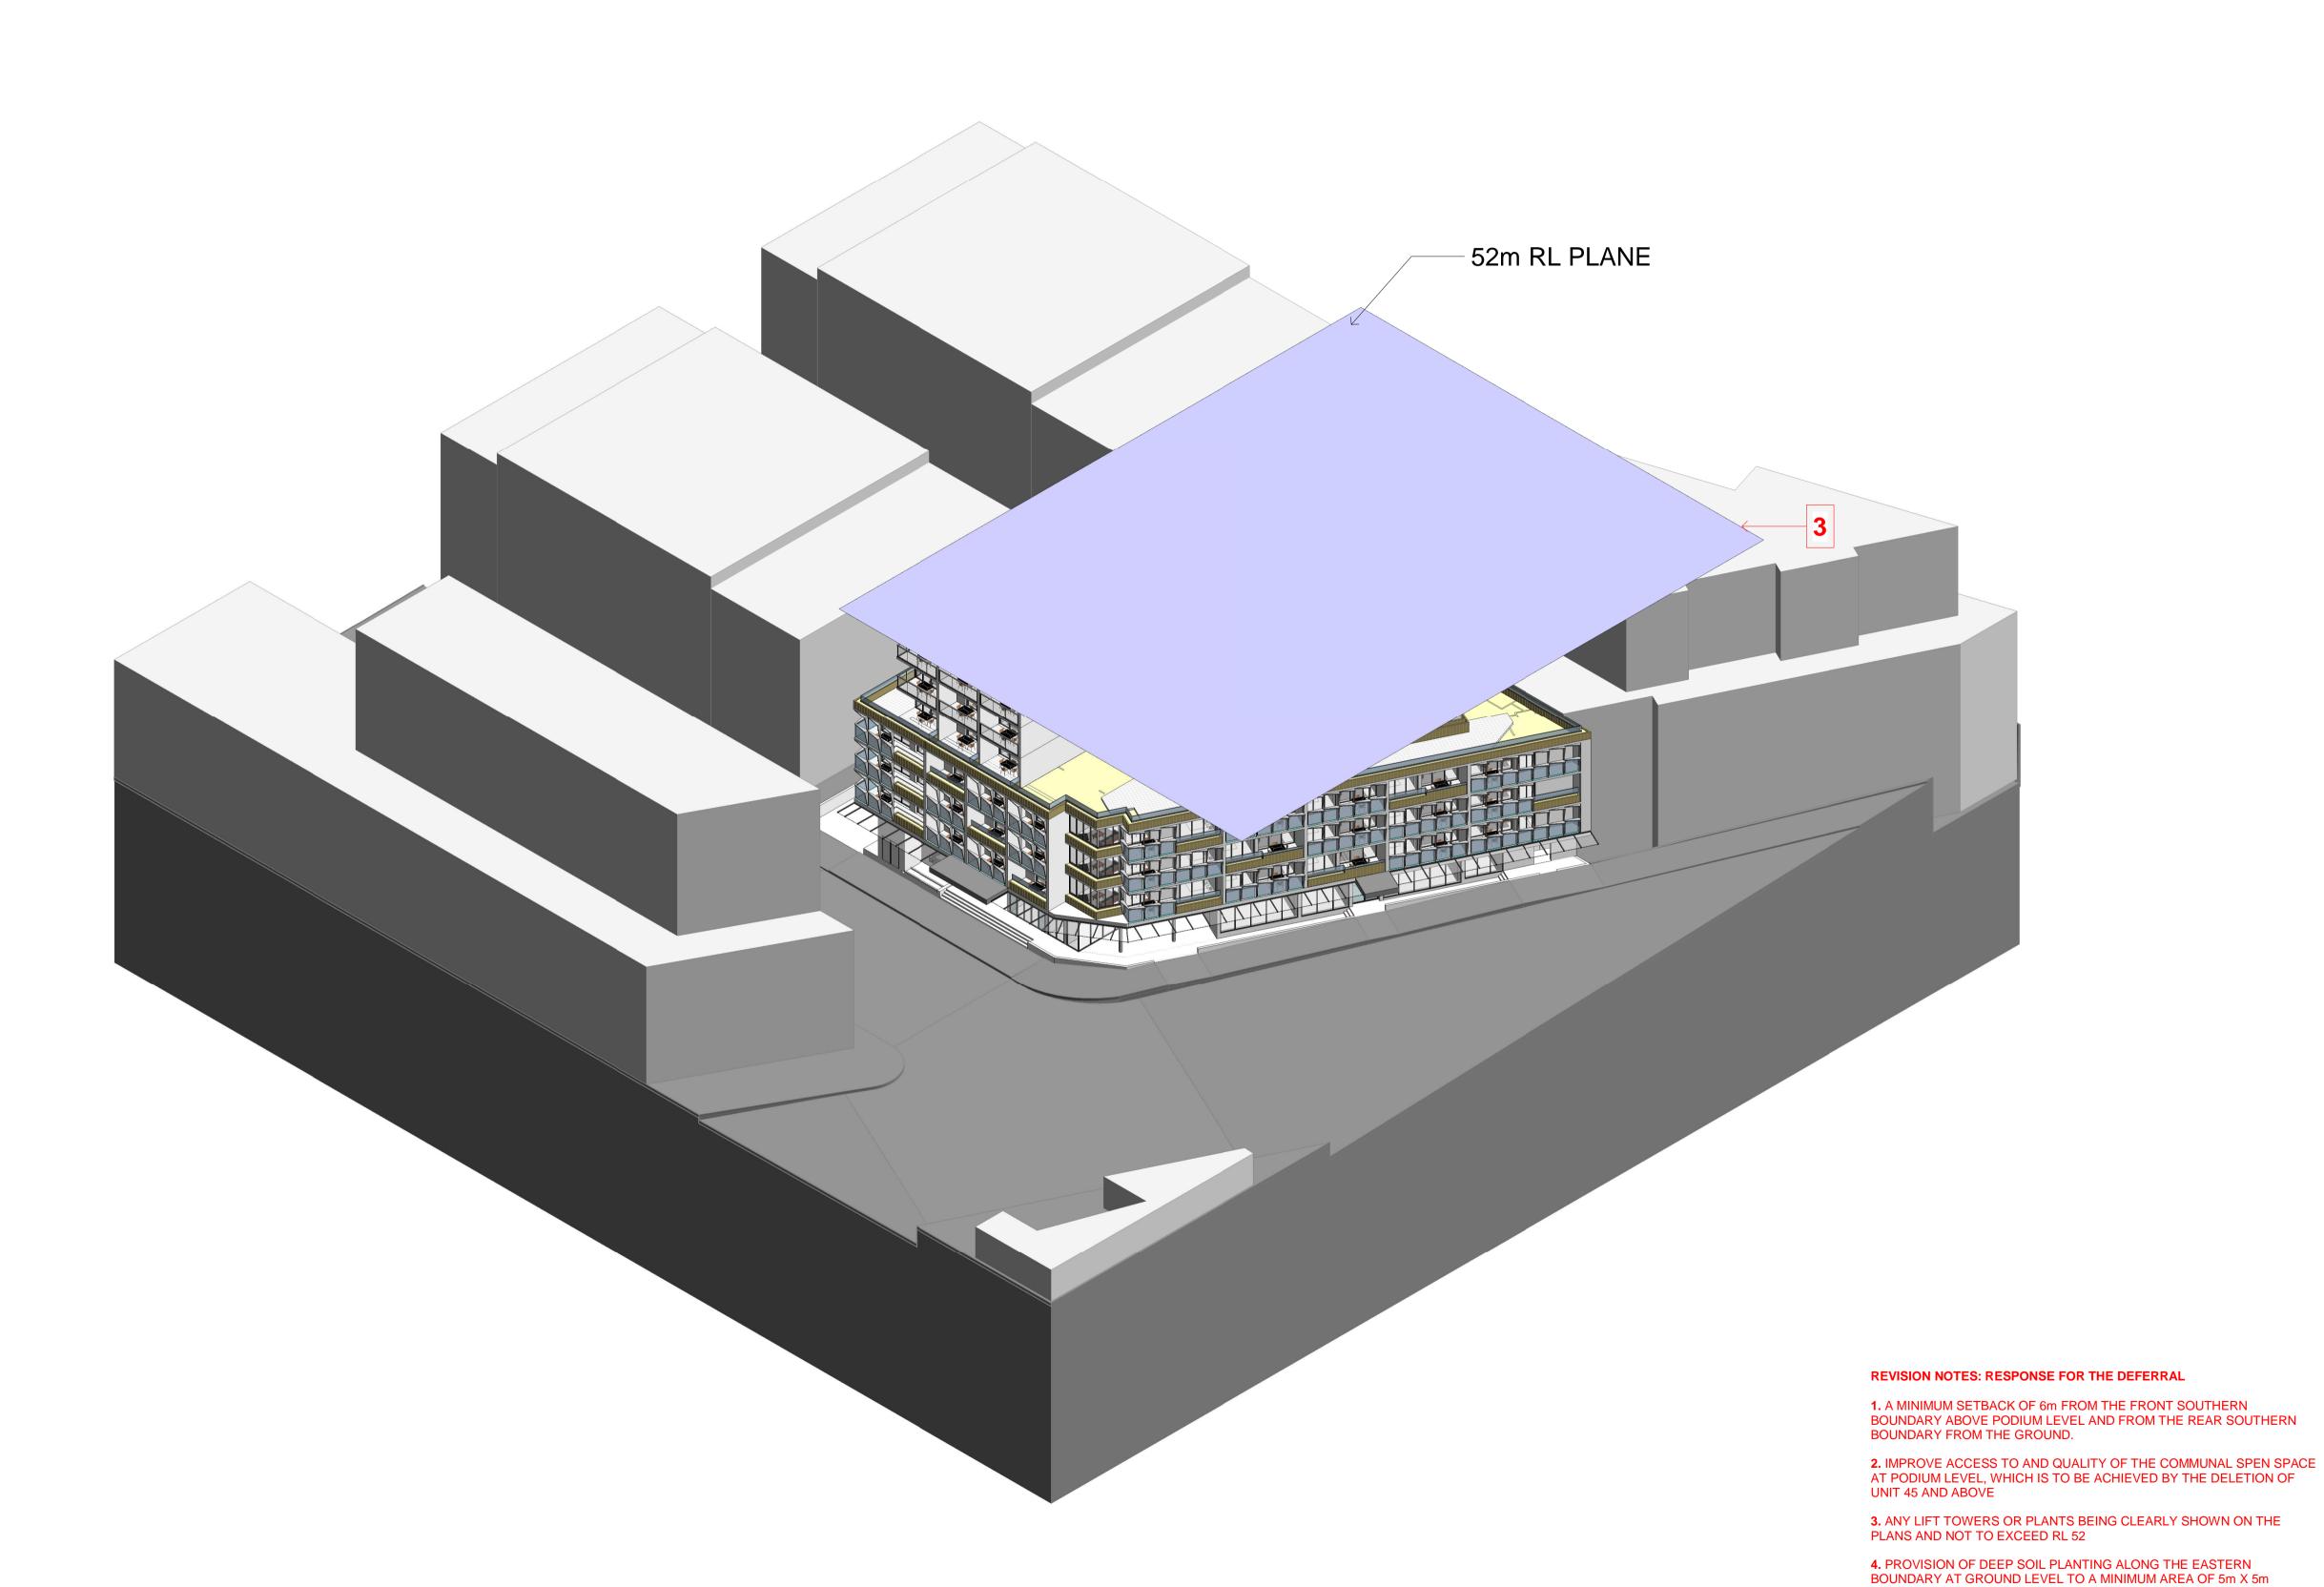

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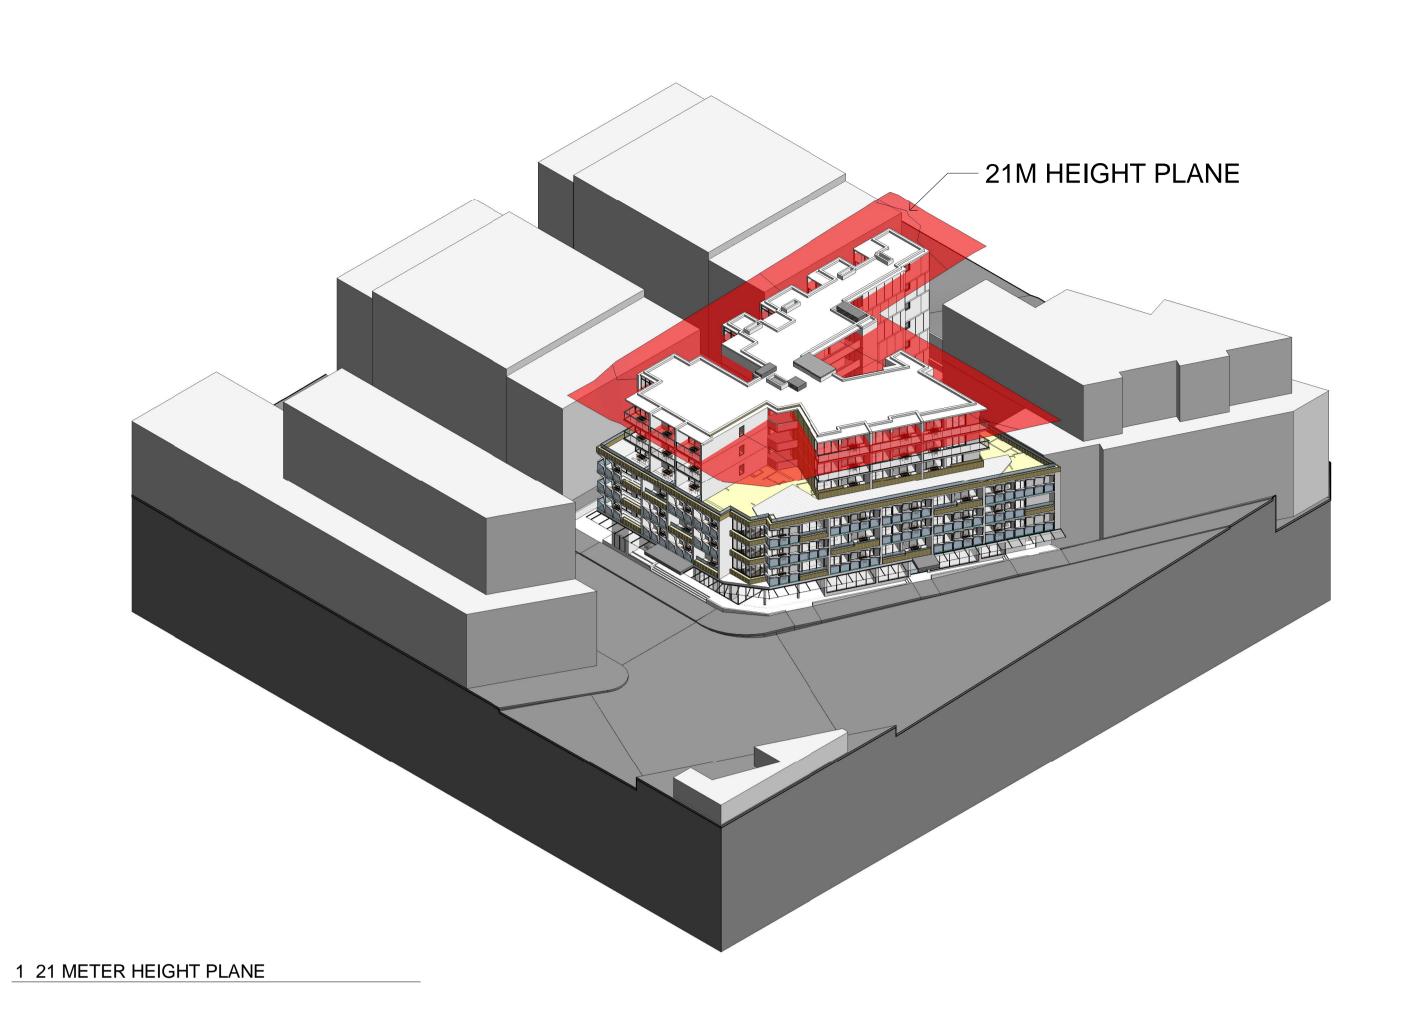
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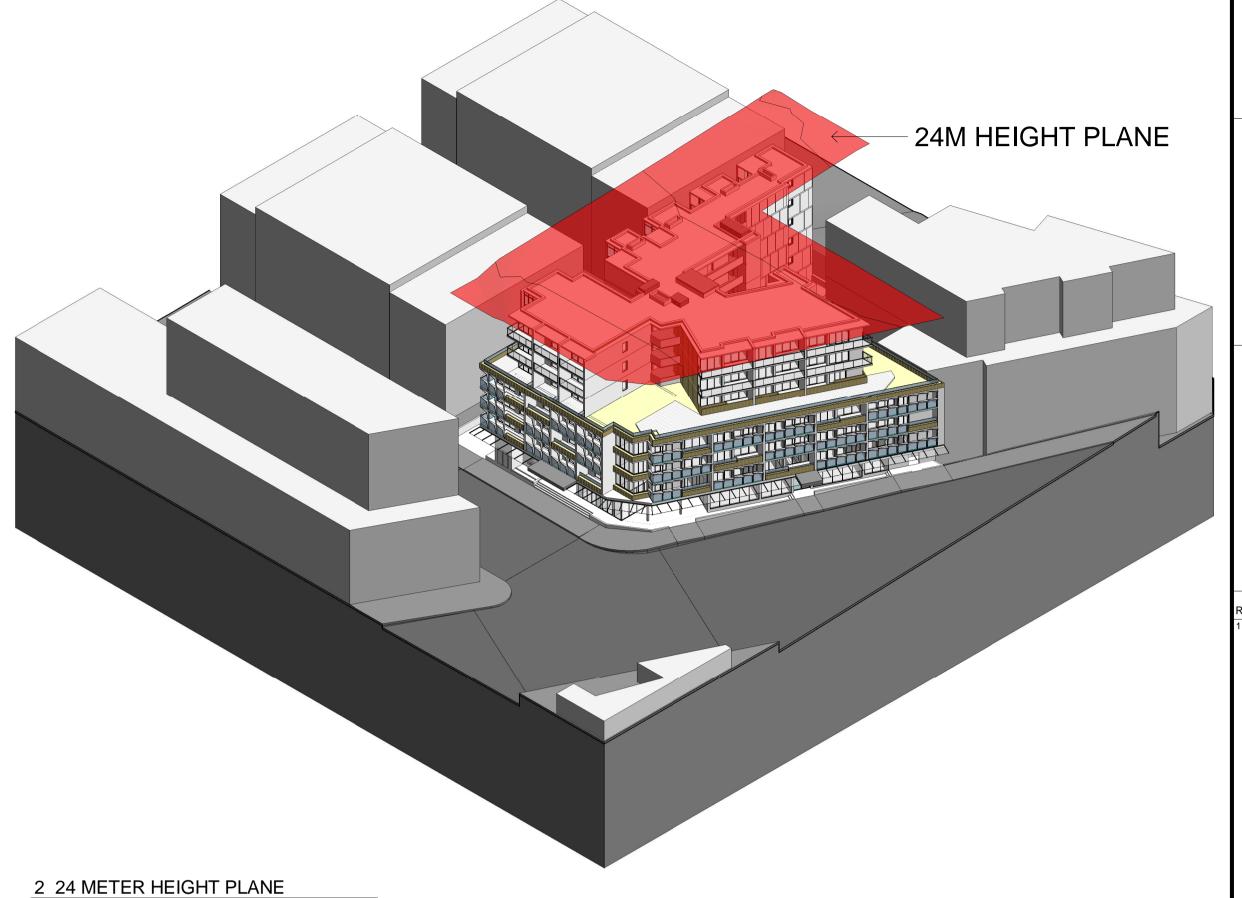
DRAWING TITLE

5. RE-CALCULATION OF THE GFA ON THE BASIS THAT GARBAGE FACILITIES NOT IN THE BASEMENT AND CORRIDORS WHICH ARE ENCLOSED ON THEIR LONG SIDE ARE INCLUDED AS FLOOR SPACE.

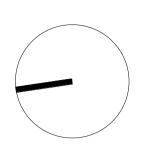52m RL PLANE DIAGRAM

SCALE	DATE	DRAWN	CHECKED
1 : 100 @A1	09/07/2018	PM	PD
JOB	DRAWING		REVISION
17079	DA9-14	•	1





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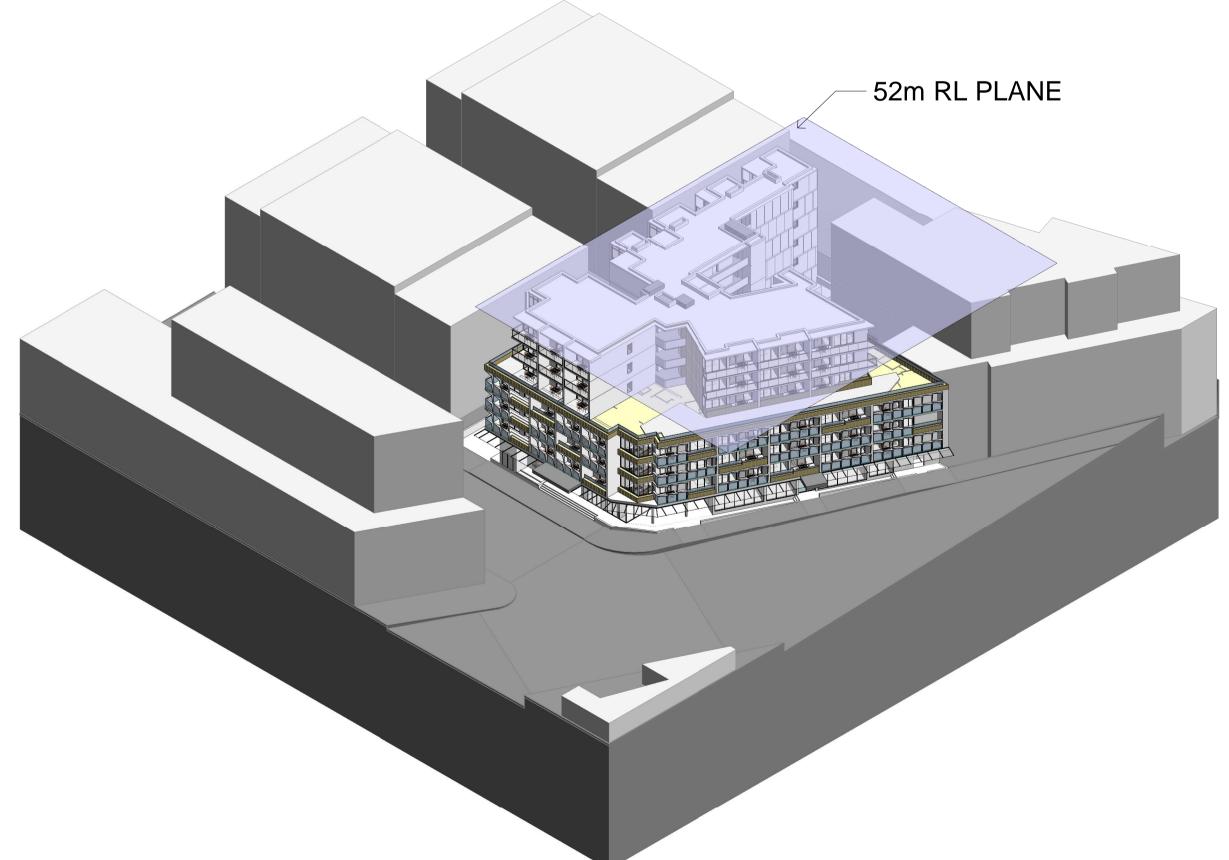


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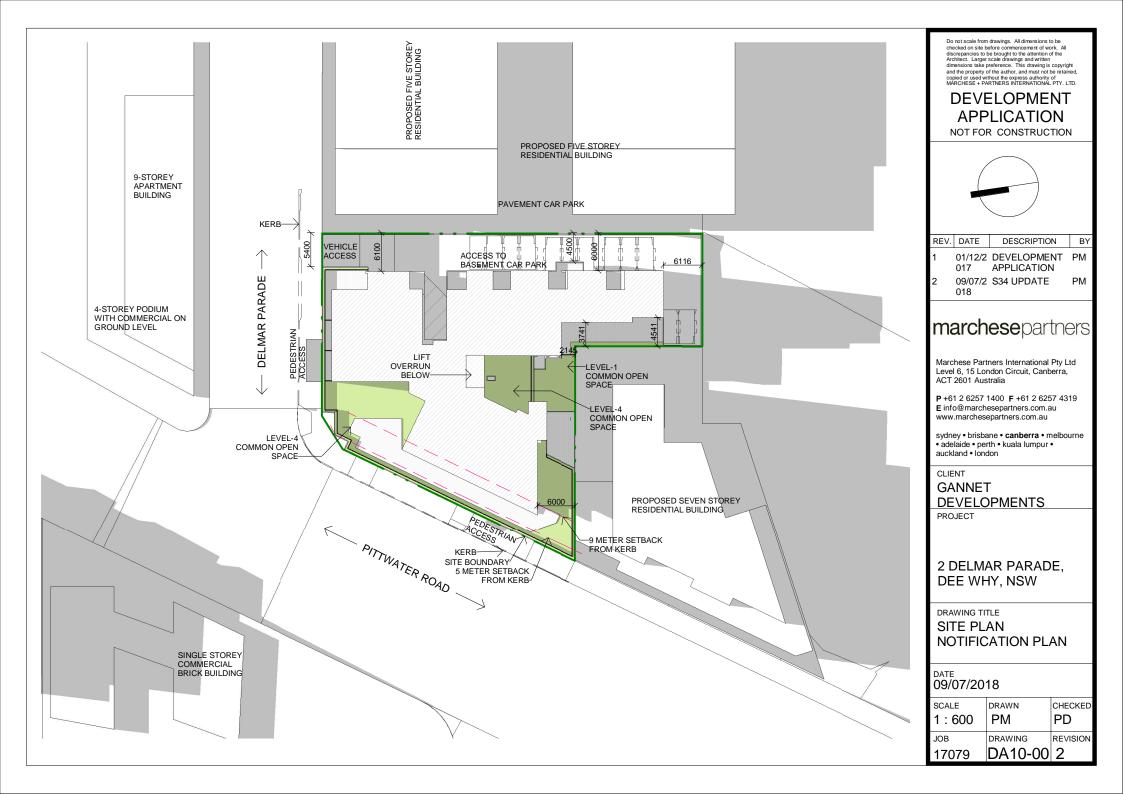
DRAWING TITLE

HEIGHT PLANES

SCALE	DATE	DRAWN	CHECKED
@A1	09/07/2018	PM	PD
ЈОВ 17079	DA9-15	DRAWING DA9-15	



3 52 METER RL PLANE





NORTH ELEVATION

1:500

PROPOSED SEVEN STOREY
RESIDENTIAL BUILDING

D.P. 220220

D.P. 710661

SOUTH ELEVATION

1:500

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DEVELOPMENT APPLICATION

NOT FOR CONSTRUCTION

REV. DATE DESCRIPTION BY

1 01/12/2 DEVELOPMENT PM
017 APPLICATION

2 09/07/2 S34 UPDATE PM

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-9-STOREY APARTMENT BUILDING

GANNET DEVELOPMENTS

PROJECT

2 DELMAR PARADE, DEE WHY, NSW

DRAWING TITLE

NORTH & SOUTH ELEVATION NOTIFICATION PLAN

DATE 09/07/2018

SCALE 1:500	DRAWN PM	CHECKED PD
JOB	DRAWING	REVISION
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EAST ELEVATION

1:500



WEST ELEVATION

1:500

Do not scale from drawings. All dimensions to be checked on site before commencement of work. All discrepancies to be brought to the attention of the Architect. Larger scale drawings and written dimensions take preference. This drawing is copyright and the property of the author, and must not be retained, copied or used without the express authority of MRCHESE + PARTICERS INTERNATIONAL PTY. LTD.

DEVELOPMENT APPLICATION

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REV. DATE DESCRIPTION BY

1 01/12/2 DEVELOPMENT PM
017 APPLICATION

PM

99/07/2 S34 UPDATE

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CLIENT

GANNET DEVELOPMENTS

PROJECT

2 DELMAR PARADE, DEE WHY, NSW

DRAWING TITLE

EAST & WEST ELEVATION NOTIFICATION PLAN

DATE 09/07/2018

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1 : 500	PM	PD
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